
BIRD MCDONALD RESIDENCE

PERMIT SET




CONCEPTUAL PROJECT IMAGE

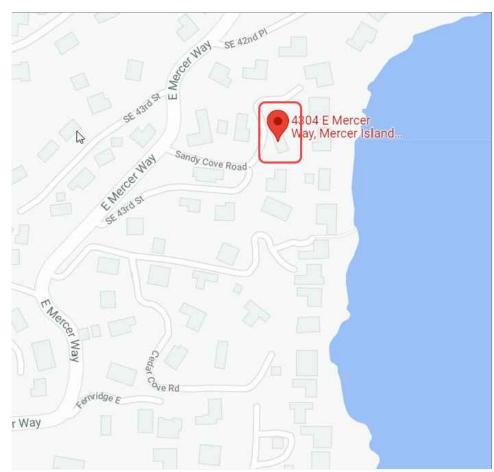

VICINITY MAP

LEGAL DESCRIPTION:

POR GL 1 BEG AT PT ON W LN OF SW 1/4 OF NE 1/4 120 FT N OF NW COR OF TR 1 ADAMS LAKE WASH TRS TH S 88-26-18 E 1504.56 FT TO PT IN CEN OF E MERCER WAY TH S 17-42-42 W 89.20 FT TH S 88-47-23 E 293.19 FT TO TPOB TH N 25-08-08 E 59.40 FT TH ALG CURVE TO LEFT RAD 87.5 FT DIST OF 76.74 FT TH ALG REVERSE CURVE TO RT RAD 37.5 FT DIST OF 76.34 FT TH ON COMP CURVE TO RGT RAD 66.75 FT DIST OF 104.48 FT TH S 01-12-37 W 113.18 FT TH N 88-47-23 W 119.44 FT TO TPOB TGW 1/3 INT IN 25 FT STRIP SHOWN AS BEACH & SH LDS ADJ TGW 1/10 INT IN PRIVATE RDWAY

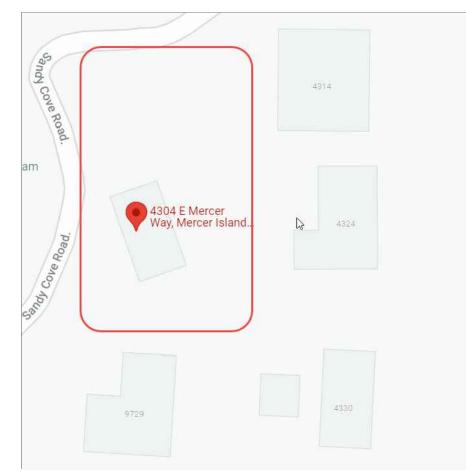

SITE

CONTACT INFORMATION:

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CIVIL ENGINEER:

DUFFY ELLIS 102 NW CANAL STREET SEATTLE, WA 98107 206-730-0372 DUFFY@CESOLUTIONS.US

CONTRACTOR: MERCER BUILDERS 3026 78th Ave SE MERCER ISLAND, WA 98040 (206) 275-1234 THOM.SCHULTZ@MERCERBUILDERS.COM

ENERGY/MECHANICAL CODE COMPLIANCE:

1) WORK TO COMPLY WITH THE 2018 WSEC AND 2018 IMC.

2) ALL GLAZING AND DOORS TO MEET MAXIMUM 0.30 U-FACTOR PER THE 2018 WSEC PRESCRIPTIVE UNLIMITED GLAZING REQUIREMENTS. REFER TO SHEET A6.1 FOR WINDOW SCHEDULE.

VERTICAL GLAZING (U): 0.30 OVERHEAD GLAZING (U): 0.50 DOOR (U): 0.30 **CEILING:**

R38 ADV. or R-49 VAULTED CEILING: R-38 **WALL ABOVE GRADE: R-21 INT**

WALL INT. BELOW GRADE: R-21 TB WALL EXT. BELOW GRADE: FLOOR: R-30 R-10 **SLAB ON GRADE:**

3) A MINIMUM OF 75 PERCENT OF ALL LIGHT FIXTURES SHALL BE HIGH EFFICACY PER WAC 51-11R.

4) PERMANENTLY MOUNTED EXTERIOR LIGHTS FIXTURES WILL BE HIGH EFFICACY UNLESS EQUIPPED WITH BUILT-IN PHOTO CONTROL SENSOR PER WSEC 505.2.

5) ALL BATHROOMS AND TOILET ROOMS TO BE EQUIPPED WITH A MINIMUM 50 CFM INTERMITTENTLY OPERATING SOURCE SPECIFIC EXHAUST FAN. ALL KITCHENS TO BE EQUIPPED WITH A MINIMUM 100 CFM INTERMITTENTLY OPERATING SOURCE SPECIFIC EXHAUST FAN PER IRC M 1507.4.

6) INTERMITTENT WHOLE HOUSE VENTILATION TO BE PROVIDED PER IRC M1507.3.

7) HEAT PUMP;

HVAC DESIGN TO INCLUDE AIR SOURCE HEAT PUMP (ENERGY CREDIT 1) 1.0 CREDITS

8) EFFICIENT BUILDING ENVELOPE; MODIFIED VERTICAL FENESTRATION U = 0.28 FLOOR R-38

SLAB ON GRADE R-10 PERIMETER AND UNDER ENTIRE SLAB, BELOW GRADE SLAB R-10 PERIMETER AND UNDER ENTIRE

(ENERGY CREDIT 1.3) 0.5 CREDITS

9) AIR LEAKAGE CONTROL AND EFFICIENT VENTILATION; REDUCE THE TESTED AIR LEAKAGE TO 1.5 AIR CHANGES PER **HOUR MAXIMUM AT 50 PASCALS** (ENERGY CREDIT 2.3) 1.5 CREDITS

10) HIGH EFFICIENCY HVAC; AIR SOURCE, CENTRALLY DUCTED HEAT PUMP WITH MINIMUM

HSPF OF 11.0 (ENERGY CREDIT 3.5) 1.5 CREDITS

11) HIGH EFFICIENCY HVAC DISTRIBUTION SYSTEM; DUCT LEAKAGE SHALL BE LIMITED TO 3CFM PER 100 SF OF CONDITIONED FLOOR AREA, AIR HANDLER SHALL BE LOCATED WITHIN THE CONDITIONED

SEE ADDITIONAL REQUIREMENTS PER WSEC TABLE 406.3 (ENERGY CREDIT 4.1) 0.5 CREDITS

12) EFFICIENT WATER HEATING; WATER HEATING SYSTEM SHALL INCLUDE ENERGY STAR RATED GAS WATER HEATER WITH A MINIMUM UEF OF 0.91 (ENERGY CREDIT 5.3) 1.0 CREDITS

TOTAL ENERGY CREDITS = 6.0 REQUIRED BASED ON TABLE R406.2 FOR MEDIUM DWELLING UNIT. ENERGY SELECTIONS FROM WSEC TABLE R406.3.

PROJECT DATA:

PARCEL NUMBER: 1824059113

PROJECT ADDRESS: 4304 E MERCER WAY MERCER ISLAND, WA 98040

LOT SIZE: 16,878 SF (0.39 ACRES)

ZONE: R-15

CONSTRUCTION TYPE: VB

AUTOMATIC SPRINKLER SYSTEM: NFPA 13R SYSTEM REQUIRED. SEE PROPOSED FIRE CODE ALTERNATIVES

ENVIRONMENTALLY CRITICAL AREAS: NONE

PROJECT DESCRIPTION:

SCOPE OF WORK INCLUDES REMOVAL OF THE EXISTING TWO STORY SINGLE FAMILY RESIDENCE AND CONSTRUCTION OF A NEW TWO STORY SINGLE FAMILY RESIDENCE

REQUIRED YARDS: FRONT YARD = 20 FT REAR YARD = 25 FT SIDE YARDS = 8.075 FT EACH

PER 95 FT DIAMETER LOT WIDTH CIRCLE $(95 \times 0.17 = 16.15 / 2 = 8.075)$

BUILDING HEIGHT:

MAX BUILDING HEIGHT = 30 FT MEASURED FROM THE AVERAGE ELEVATION OF EXISTING GRADE AROUND THE BUILDING PROPOSED BUILDING HEIGHT, SEE A3.1-A3.2

PROJECT GROSS SQUARE FOOTAGE: MEASURED FROM EXTERIOR WALLS. INCLUDES UNHEATED AREAS.

GROSS SQUARE FOOTAGE = 4,536 SF UPPER LEVEL 2,476 SF LOWER LEVEL 2,060 SF

SHEET LIST:

GENERAL:

G0.0 TITLE SHEET G0.1 GENERAL CONDITIONS + ABBREVIATIONS

SURVEY

C1.0 TESC AND TREE RETENTION PLAN

C1.2 TESC DETAILS C2.0 DRAINAGE PLAN

C3.5 BMP

ARCHITECTURAL:

D1.1 SITE DEMOLITION PLAN

A0.1 ZONING DIAGRAMS

A1.1 SITE PLAN

A2.1 FOUNDATION PLAN A2.2 LOWER LEVEL PLAN A2.3 UPPER LEVEL PLAN A2.4 CLERESTORY PLAN

A2.5 ROOF PLAN

A3.1 BUILDING ELEVATIONS A3.2 BUILDING ELEVATIONS

A4.1 BUILDING SECTIONS A4.2 BUILDING SECTIONS

A5.1 WALL ASSEMBLIES

A5.2 FLOOR ASSEMBLIES

A5.3 ROOF ASSEMBLIES

A6.1 WINDOW & DOOR SCHEDULE

A6.2 WINDOW & DOOR SCHEDULE

A8.1 EXTERIOR DETAILS

A8.2 EXTERIOR DETAILS

A8.3 EXTERIOR DETAILS

A8.4 EXTERIOR DETAILS

STRUCTURAL:

S1.0 GENERAL NOTES

S2.1 BASEMENT PLAN S2.2 FIRST FLOOR FRAMING PLAN

S2.3 LOWER ROOF FRAMING PLAN

S2.4 ROOF FRAMING PLAN

S3.1 FOUNDATION DETAILS

S4.1 FRAMING DETAILS S4.2 FRAMING DETAILS



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4304 E MERCER WAY

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MERCER ISLAND, WA 98040

CLIENT:

SEATTLE, WA 98103 PH: 206.729.0480 WWW.MCCARCH.COM

OCTOBER 25, 2021

SHEET TITLE:

DATE:

TITLE SHEET

SHEET:

PROJECT RESIDENCE PERMIT SET

ABBREVIATIONS:

AA BBBBBBBB CCCCCCCCCCCCCCCCCCCCCCCCCCC	ABOVE ACQUISTIC, ACOUSTICAL ACCESSORY ADDENDUM ADDITIONAL ADJUSTABLE ABOVE FINISHED FLOOR ABOVE FINISHED FLOOR ABOVE FINISHED GRADE ALTERNATE, ALTERNATIVE ALUMINUM ANCHOR APPROXIMATELY ARCHITECT, ARCHITECTURAL BASEBOARD BUILDING BUILDING BUILDING BLOCKING BELOW BEAM BOTTOM OF BOARD BETWEEN CABINET CALCULATION CENTERLINE CONTROL JOINT CELLING CLEAR CONCRETE MASONRY UNIT COUNTER, COUNTER SUNK COLUMN CONCRETE CONTINUOUS CORRIDOR CARPET CONTINUOUS CORRIDOR CARPET CERAMIC TILE CENTER DOUBLE DEGREE DEPARTMENT DIAMETER DIMENSION DISPENSER DOWN DOWN SPOUT DISHWASHER DRAWING EAST EACH ELEVATION ELEVATOR ENGINEER EQUIAL EQUIPMENT EQUIVALENT EQUIVALENT EXPANSION, EXPOSED EXISTING EXTERIOR FABRICATE FLOOR DRAIN FOUNDATION FIRE EXTINGUISHER CABINET FINISH FLOOR FINISH FLOOR FINISH FLOOR FEET, FOOT FOOTING FURRING, FURRED FIELD VERIFY GAUGE GALVANIZED GENERAL CONTRACTOR GLASS, GLAZING GOTT GYPSUM WALL BOARD HOSE BIB HEAD HARDWOOD HEADER HOLLOW METAL HORIZONTAL HORI	SPEC SQ SS STD STL STOR STRUCT T **********************************	RISER RECCOMENDED REFERANCE REFRIGERATOR REINFORCED REQUIRED RETAINING ROUGH OPENING SOUTH SOLID CORE SCHEDULE SOLID CORE WOOD SQUARE FEET, SQUARE FOOT SAFETY GLAZING SHEATHING SIMILAR SPECIFICATION SQUARE STAINLESS STEEL STANDARD STEEL STORAGE STRUCTURAL TEMPERED SAFETY GLASS TOP AND BOTTOM TEMPORARY TONGUE AND GROOVE THROUGH TOP OF TOP OF MASONRY TOP OF SLAB TOP OF WALL TYPICAL UNLESS NOTED OTHERWISE VERTICAL VENT TO OUTSIDE
HD HDWD HDR HM HORIZ HR	HEAD HARDWOOD HEADER HOLLOW METAL HORIZONTAL HOUR	TOSL TOW TYP UNO VERT VTO	TOP OF SLAB TOP OF WALL TYPICAL UNLESS NOTED OTHERWISE VERTICAL VENT TO OUTSIDE
		VTR W W/O WND WD W/R WWF	VENT THROUGH ROOF WEST WITH WITHOUT WINDOW WOOD WATER RESISTANT WELDED WIRE FABRIC

GENERAL PLAN NOTES:

- REFER TO SHEET A5.1 FOR WALL, FLOOR AND ROOF ASSEMBLY TYPES
- ALL DIMENSIONS ARE TO FACE OF STUD OR FACE OF CONCRETE UNLESS OTHERWISE NOTED
- INTERIOR DOORS TO BE INSTALLED 4-1/2" FROM FACE OF STUD TO EDGE OF ROUGH OPENING IF NOT DIMENSIONED
- ALL WINDOW DIMENSIONS ARE TO ROUGH OPENING
- REFER TO STRUCTURAL DOCUMENTS FOR ALL CONCRETE & FRAMING **INFORMATION**

SYMBOLS:

WINDOW TYPE W101

ED101

EXTERIOR DOOR TYPE



DOOR TYPE



SECTION CALL OUT

ASSEMBLY TYPE



SMOKE DETECTOR

100 CFM FAN

CARBON MONOXIDE DETECTOR

DOWNSPOUT

FLOOR DRAIN



GENERAL CONSTRUCTION NOTES:

- 1) THE CONTRACTOR SHALL CAREFULLY STUDY AND COMPARE THE CONTRACT DOCUMENTS WITH EACH OTHER AND WITH INFORMATION FURNISHED BY THE OWNER AND SHALL AT ONCE REPORT TO THE ARCHITECT ERRORS, INCONSISTENCIES OR OMISSIONS DISCOVERED. IF THE CONTRACTOR PERFORMS ANY CONSTRUCTION ACTIVITY KNOWING IT INVOLVES A RECOGNIZED ERROR, INCONSISTENCY OR OMISSION IN THE CONTRACT DOCUMENTS WITHOUT SUCH NOTICE TO THE ARCHITECT, THE CONTRACTOR SHALL ASSUME APPROPRIATE RESPONSIBILITY FOR SUCH PERFORMANCE AND SHALL BEAR AN APPROPRIATE AMOUNT OF THE ATTRIBUTABLE COSTS FOR CORRECTION.
- 2) BEFORE ORDERING MATERIALS OR DOING ANY WORK, THE GENERAL CONTRACTOR AND ALL OF THE SUB-CONTRACTORS SHALL VERIFY ALL MEASUREMENTS ON THE DRAWINGS AND AT THE CONSTRUCTION SITE, AND SHALL BE RESPONSIBLE FOR THEIR CORRECTNESS. NO EXTRA COMPENSATION WILL BE ALLOWED ON ACCOUNT OF DIFFERENCES BETWEEN ACTUAL DIMENSIONS AND THOSE INDICATED ON THE DRAWINGS. ANY DISCOVERED DIFFERENCES SHALL BE REPORTED TO THE ARCHITECTS FOR DESIGN CONSIDERATIONS BEFORE PROCEEDING FURTHER WITH THE WORK. THE CONTRACTOR IS HEREBY ADVISED THAT THE DRAWINGS ARE NOT TO SCALE.
- 3) WORK SHALL CONFORM TO APPLICABLE CODES AND REGULATIONS OF AGENCIES HAVING
- 4) CONTRACTOR SHALL KEEP ALL AREAS UNDER CONSTRUCTION CLEAR OF DIRT AND DEBRIS.
- 5) CONTRACTOR SHALL REPAIR DAMAGED SURFACES WHICH WERE DAMAGED BY CONSTRUCTION OR CLEAN-UP, AND CORRECT CONDITIONS TO MATCH SURROUNDING FINISHED CONDITIONS.
- REPETITIVE FEATURES NOT NOTED ON THE DRAWINGS SHALL BE COMPLETELY PROVIDED AS DRAWN IN FULL.
- DIMENSIONS ON DRAWINGS ARE TAKEN TO THE FACE OF CONCRETE AND TO THE FACE OF STUD, UNLESS OTHERWISE NOTED. FIELD VERIFY ALL DIMENSIONS.
- FIELD VERIFY MILLWORK DIMENSIONS AND ALL WINDOW AND DOOR DIMENSIONS.
- 9) PROTECT ALL PORTIONS OF THE EXISTING BUILDING OR SITE NOT SCHEDULED TO BE REMOVED, IF APPLICABLE, AND REPLACE OR REPAIR ALL SUCH ITEMS DAMAGED DURING CONSTRUCTION. PROVIDE PROTECTION AGAINST INCLEMENT WEATHER, WIND, FROST, EXCESSIVE HEAT, VANDALISM, AND ALL WORKERS, DELIVERY PERSONNEL, SUB-CONTRACTORS AND BUILDING INSPECTORS SO AS TO MAINTAIN ALL WORK, MATERIAL, APPARATUS AND FIXTURES FREE FROM DAMAGE, INCLUDING SURFACE SCRATCHES AND BLEMISHES. ALL NEW AND EXISTING WORK LIKELY TO BE DAMAGED SHALL BE APPROPRIATELY COVERED OR PROTECTED AT ALL TIMES. PROTECT ALL PLANTING AREAS FROM FOOT OR WHEEL TRAFFIC, AND AVOID CRUSHING SAME DUE TO STORED MATERIAL.S.

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MERCER ISLAND, WA 98040

CLIENT:

CARLY BIRD-VOGEL & PAUL MCDONALD 4304 E MERCER WAY MERCER ISLAND, WA 98040

PERMIT SUBMISSION 2021-10-25

OCTOBER 25, 2021

SHEET TITLE:

GENERAL CONDITIONS + ABBREVIATIONS

BEGINNING AT A POINT MARKED BY AN IRON PIPE SET ON THE WEST LINE OF THE SOUTHWEST QUARTER OF THE NORTHEAST QUARTER OF SAID SECTION, WHICH POINT IS NORTH 01°08'16" EAST 120 FEET FROM THE NORTHWEST CORNER OF TRACT 1, ADAMS LAKE WASHINGTON TRACTS, ACCORDING TO THE PLAT THEREOF RECORDED IN VOLUME 11 OF PLATS, PAGE 80, RECORDS OF KING COUNTY,

THENCE SOUTH 88°26'18" EAST ALONG A LINE PARALLEL WITH THE NORTH LINE OF SAID TRACT 1 AND THE EASTERLY PRODUCTION THEREOF, 1,504.56 FEET TO A POINT MARKED BY AN IRON PIPE SET IN THE CENTERLINE OF EAST MERCER WAY;

THENCE SOUTH 17°42'42" WEST 89.20 FEET TO A POINT MARKED BY AN IRON PIPE ON THE EASTERLY LINE OF SAID EAST MERCER WAY: THENCE SOUTH 88°47'23" EAST ALONG A FENCE LINE AS IT EXISTED JUNE 30, 1952, DATE OF BOUNDARY LINE AGREEMENT RECORDED UNDER RECORDING NUMBER 4254660, OR THE PRODUCTION THEREOF, 293.19 FEET TO THE TRUE POINT OF BEGINNING OF THIS

THENCE NORTH 25°08'08" EAST 59.40 FEET;

THENCE ALONG A CURVE TO THE LEFT HAVING A RADIUS OF 87.5 FEET, THROUGH AN ARC OF 50°15'00" A DISTANCE OF 76.74 FEET; THENCE ALONG A REVERSE CURVE TO THE RIGHT HAVING A RADIUS OF 37.5 FEET, THROUGH AN ARC OF 116°38'40" A DISTANCE OF

THENCE ON A COMPOUND CURVE TO THE RIGHT, HAVING A RADIUS OF 66.75 FEET, THROUGH AN ARC OF 89°40'49" A DISTANCE OF

THENCE SOUTH 1°12'37" WEST 113.18 FEET TO THE AFOREMENTIONED FENCE LINE, OR THE PRODUCTION THEREOF;

THENCE NORTH 88°47'23" WEST ALONG SAID FENCE LINE. OR ITS PRODUCTION, 119.44 FEET TO THE TRUE POINT OF BEGINNING. TOGETHER WITH A 1/10TH INTEREST IN A PRIVATE ROADWAY, BEING THE FOLLOWING DESCRIBED PORTION OF GOVERNMENT LOT 1, SECTION 18, TOWNSHIP 24 NORTH, RANGE 5 EAST, W.M., IN KING COUNTY, WASHINGTON, DESCRIBED AS FOLLOWS:

BEGINNING AT A POINT MARKED BY AN IRON PIPE SET ON THE WEST LINE OF THE SOUTHWEST QUARTER OF THE NORTHEAST QUARTER OF THE NORTHEAST QUARTER OF SAID SECTION, WHICH POINT IS NORTH 01°08'16" EAST 120 FEET FROM THE NORTHWEST CORNER OF TRACT 1, ADAMS LAKE WASHINGTON TRACTS, ACCORDING TO THE PLAT THEREOF RECORDED IN VOLUME 11 OF PLATS, PAGE(S) 80, IN KING COUNTY, WASHINGTON;

THENCE SOUTH 88°26'18" EAST ALONG A LINE PARALLEL WITH THE NORTH LINE OF SAID TRACT AND THE EASTERLY PRODUCTION THEREOF, 1,504.56 FEET TO A POINT MARKED BY AN IRON PIPE SET IN THE CENTERLINE OF EAST MERCER WAY;

THENCE SOUTH 17°42'42" WEST 89.20 FEET TO A POINT MARKED BY AN IRON PIPE ON THE SOUTHEASTERLY LINE OF SAID EAST MERCER WAY AND THE TRUE POINT OF BEGINNING OF THIS DESCRIPTION; THENCE SOUTH 88°47'23" EAST ALONG A FENCE LINE AS IT EXISTED JUNE 30, 1952, DATE OF BOUNDARY AGREEMENT RECORDED UNDER RECORDING NUMBER 4254660, OR THE PRODUCTION THEREOF, 293.19 FEET;

THENCE NORTH 25°08'08" EAST 59.40 FEET; THENCE ALONG A CURVE TO THE LEFT HAVING A RADIUS OF 87.5 FEET THROUGH AN ARC OF 50°15'00" A DISTANCE OF 76.74 FEET; THENCE ALONG A REVERSE CURVE TO THE RIGHT HAVING A RADIUS

OF 37.5 FEET THROUGH AN ARC OF 116°38'40" A DISTANCE OF

THENCE ON A COMPOUND CURVE TO THE RIGHT, HAVING A RADIUS OF 66.75 FEET THROUGH AN ARC OF 89°40'49" A DISTANCE OF 104.58 FEET;

THENCE SOUTH 01°12'37" WEST 113.18 FEET TO THE AFOREMENTIONED FENCE LINE, OR THE PRODUCTION THEREOF; THENCE ALONG SAID FENCE LINE, OR PRODUCTION, SOUTH 88°47'23" EAST 25.00 FEET TO THE SOUTHWESTERLY CORNER OF THE

COMMUNITY BEACH TRACT KNOWN AS TRACT "A": THENCE ALONG THE WESTERLY LINE OF SAID BEACH TRACT AND THE PRODUCTION THEREOF, NORTH 01°12'37" EAST 204.93 FEET, MORE OR LESS, TO A LINE 240.0 FEET NORTH OF AND PARALLEL WITH THE EASTERLY PRODUCTION OF THE NORTH LINE OF TRACT 1, ADAMS LAKE WASHINGTON TRACTS;

THENCE NORTH 88°28'12" WEST ALONG SAID PARALLEL LINE 143.33

THENCE SOUTH 10°09'37" WEST 53.71 FEET;

THENCE ALONG A CURVE TO THE LEFT HAVING A RADIUS OF 62.5 FEET THROUGH AN ARC OF 35°16'29" A DISTANCE OF 38.48 FEET; THENCE ALONG A REVERSE CURVE TO THE RIGHT HAVING A RADIUS OF 62.5 FEET, THROUGH AN ARC OF 116°19'29" A DISTANCE OF 126.89 FEET TO A POINT ON A LINE PARALLEL WITH AND 25.0 FEET NORTHERLY FROM THE AFOREMENTIONED FENCE LINE, OR THE PRODUCTION THEREOF;

THENCE NORTH 88°47'23" WEST ALONG SAID PARALLEL LINE 210.88 FEET, MORE OR LESS, TO THE SOUTHWESTERLY LINE OF EAST MERCER WAY:

THENCE SOUTH 44°00'05" WEST ALONG SAID SOUTHWESTERLY LINE 34.06 FEET TO THE TRUE POINT OF BEGINNING; AND TOGETHER WITH A 1/3RD INTEREST IN THE FOLLOWING DESCRIBED PORTION OF GOVERNMENT LOT 1, SECTION 18, TOWNSHIP

24 NORTH, RANGE 5 EAST, W.M., IN KING COUNTY, WASHINGTON, AND THAT PORTION OF ADJOINING SECOND CLASS SHORELANDS, LYING ABOVE THE LEVEL OF THE WATERS OF LAKE WASHINGTON, DESCRIBED AS FOLLOWS:

BEGINNING AT A POINT MARKED BY AN IRON PIPE SET ON THE

WEST LINE OF THE SOUTHWEST QUARTER OF THE NORTHEAST QUARTER OF SAID SECTION, WHICH POINT IS NORTH 01°18'16" EAST 120 FEET FROM THE NORTHWEST CORNER OF TRACT 1, ADAMS LAKE WASHINGTON TRACTS, ACCORDING TO THE PLAT THEREOF RECORDED IN VOLUME 11 OF PLATS, PAGE 80, IN KING COUNTY, WASHINGTON; THENCE SOUTH 88°26'18" EAST ALONG A LINE PARALLEL WITH THE NORTH LINE OF SAID TRACT AND THE EASTERLY PRODUCTION THEREOF, 1,504.56 FEET TO A POINT MARKED BY AN IRON PIPE SET

IN THE CENTERLINE OF EAST MERCER WAY; THENCE SOUTH 17°42'42" WEST 89.20 FEET TO A POINT MARKED BY AN IRON PIPE ON THE SOUTHEASTERLY LINE OF SAID EAST MERCER

THENCE SOUTH 88°47'23" EAST ALONG A FENCE AS IT EXISTED JUNE 30, 1952, DATE OF BOUNDARY LINE AGREEMENT RECORDED UNDER RECORDING NUMBER 4254660, OR THE PRODUCTION THEREOF, 437.63 FEET TO THE TRUE POINT OF BEGINNING; THENCE CONTINUING SOUTH 88°47'23" EAST 151.08 FEET, MORE OR

LESS, TO THE SHORE OF LAKE WASHINGTON; THENCE NORTHERLY ALONG SAID SHORE 25.0 FEET, MORE OR LESS, TO A LINE PARALLEL WITH, AND NORTH 01°12'37" EAST 25.0 FEET FROM THE AFOREMENTIONED FENCE LINE, OR THE PRODUCTION

THENCE NORTH 88°47'23" WEST ALONG SAID PARALLEL LINE 153.0 FEET, MORE OR LESS, TO A POINT WHICH BEARS NORTH 01°12'37" EAST FROM THE TRUE POINT OF BEGINNING; THENCE SOUTH 01°12'37" WEST 25.0 FEET TO THE TRUE POINT OF

TOGETHER WITH REMAINING SECOND CLASS SHORELANDS ADJOINING SAID PREMISES.

SITUATE IN THE COUNTY OF KING, STATE OF WASHINGTON.

THEREOF;

TOPOGRAPHIC & BOUNDARY SURVEY

1. PERPETUAL RIGHT TO USE WATER ARISING IN SPRINGS UPON SAID PREMISES AND EASEMENT TO LAY AND MAINTAIN WATER PIPES THEREON, DISCLOSED BY INSTRUMENT RECORDED NOVEMBER 5, 1921 UNDER RECORDING NO. 1565522, WHICH RIGHT AND EASEMENT TO BE USED ONLY IN CONNECTION WITH THE PREMISES ADJOINING ON THE SOUTH, TO WIT:

SCHEDULE B ITEMS

THE NORTH HALF OF TRACT 1, ADAMS LAKE WASHINGTON TRACTS. (NOT PLOTTED, BLANKET IN NATURE)

2. EASEMENT(S) FOR THE PURPOSE(S) SHOWN BELOW AND RIGHTS INCIDENTAL THERETO, AS GRANTED IN A DOCUMENT: PURPOSE: ELECTRIC TRANSMISSION AND/OR DISTRIBUTION SYSTEM

RECORDING NO.: 2982759 AFFECTS: SOUTH 120 FEET OF THAT PORTION OF SAID GOVERNMENT LOT 1, LYING NORTH OF AND ADJACENT TO THE NORTH LINE OF SAID TRACT 1, ADAMS LAKE WASHINGTON TRACTS

3. EASEMENT(S) FOR THE PURPOSE(S) SHOWN BELOW AND RIGHTS INCIDENTAL THERETO, AS GRANTED IN A DOCUMENT: GRANTED TO: MERCER ISLAND SEWER DISTRICT

PURPOSE: SEWER PIPE LINES RECORDING DATE: NOVEMBER 12, 1964

(NOT PLOTTED DOCUMENT ILLEGIBLE)

RECORDING DATE: JANUARY 31, 1938

RECORDING NO.: 5810603 AFFECTS: SAID SHORE LANDS

(NOT PLOTTED, EASEMENT IS OVER FACILITIES AS CONSTRUCTED)

4. EASEMENT(S) FOR THE PURPOSE(S) SHOWN BELOW AND RIGHTS INCIDENTAL THERETO, AS GRANTED IN A DOCUMENT: PURPOSE: SIDE SEWER

RECORDING DATE: JUNE 25, 1968 RECORDING NO.: 6367676

(PLOTTED)

5. EASEMENT(S) FOR THE PURPOSE(S) SHOWN BELOW AND RIGHTS INCIDENTAL THERETO. AS GRANTED IN A DOCUMENT GRANTED TO: WASHINGTON NATURAL GAS COMPANY, A WASHINGTON CORPORATION

PURPOSE: GAS PIPELINE OR PIPELINES

RECORDING DATE: DECEMBER 19, 1988 RECORDING NO.: 8812190662

AFFECTS: PORTION OF PRIVATE ROADWAY SAID EASEMENT IS ALSO DISCLOSED BY NUMEROUS INSTRUMENTS OF

RECORD. (NOT PLOTTED, BLANKET IN NATURE)

6. EASEMENT(S) FOR THE PURPOSE(S) SHOWN BELOW AND RIGHTS INCIDENTAL THERETO. AS GRANTED IN A DOCUMENT: GRANTED TO: CITY OF MERCER ISLAND, A WASHINGTON MUNICIPAL

PURPOSE: CONSTRUCTION OF WATER SYSTEM RECORDING DATE: JULY 3, 2013 RECORDING NO.: 20130703001031

AFFECTS: PORTION OF SAID PREMISES

(PLOTTED)

7. PUBLIC AND/OR PRIVATE EASEMENTS, IF ANY, IN EXISTENCE VER, UNDER, ALONG AND ACROSS THAT PORTION OF REAL ESTATE UNDER SEARCH LYING WITHIN THE PRIVATE ROADWAY. (NOT PLOTTED, BLANKET IN NATURE)

8. EXCEPTIONS AND RESERVATIONS CONTAINED IN DEED WHEREBY THE GRANTOR EXCEPTS AND RESERVES ALL OIL, GASES, COAL,

MINERALS, FOSSILS, ETC., AND THE RIGHT OF ENTRY FOR OPENING, DEVELOPING AND WORKING THE SAME AND PROVIDING THAT SUCH RIGHTS SHALL NOT BE EXERCISED UNTIL PROVISION HAS BEEN MADE FOR FULL PAYMENT OF ALL DAMAGES SUSTAINED BY REASON OF SUCH ENTRY

GRANTOR: STATE OF WASHINGTON RECORDING NO.: 707849

RECORDING NO.: 3117173 (NOT PLOTTED, BLANKET IN NATURE)

NOTE: THIS EXCEPTION DOES NOT INCLUDE PRESENT OWNERSHIP OF THE ABOVE MINERAL RIGHTS. AFFECTS: SECOND CLASS SHORE LANDS

9. NOTICE OF ADDITIONAL TAP OR CONNECTION CHARGES AND THE TERMS AND CONDITIONS THEREOF: RECORDING DATE: DECEMBER 6, 1977

RECORDING NO.: 7712060812 (NOT PLOTTED, NOT SURVEY RELATED)

10. AGREEMENT AND THE TERMS AND CONDITIONS THEREOF: EXECUTED BY: OWNERS OF TRACTS A AND OWNERS OF TRACT B RECORDING DATE: NOVEMBER 1, 1994

RECORDING NO.: 9411010574 REGARDING: COMMUNITY WATERFRONT JOINT USE (PLOTTED)

11. INDEMNIFICATION AND HOLD HARMLESS AGREEMENT AND THE TERMS AND CONDITIONS THEREOF: RECORDING DATE: JUNE 27, 2019

RECORDING NO.: 20190627000159 (NOT PLOTTED, NOT SURVEY RELATED)

(NOT PLOTTED, BLANKET IN NATURE)

OR WAS FORMERLY COVERED BY WATER.

(NOT PLOTTED, BLANKET IN NATURE)

12. QUESTION OF LOCATION OF LATERAL BOUNDARIES OF SAID SECOND CLASS TIDELANDS OR SHORELANDS. (NOT PLOTTED, BLANKET IN NATURE)

13. ANY QUESTION THAT MAY ARISE DUE TO SHIFTING AND CHANGING IN THE COURSE, BOUNDARIES OR HIGH WATER LINE OF LAKE WASHINGTON.

14. RIGHTS OF THE STATE OF WASHINGTON IN AND TO THAT PORTION, IF ANY, OF THE LAND WHICH LIES BELOW THE LINE OF

ORDINARY HIGH WATER OF LAKE WASHINGTON. (NOT PLOTTED, BLANKET IN NATURE) 15. ANY PROHIBITION OR LIMITATION OF USE, OCCUPANCY OR IMPROVEMENT OF THE LAND RESULTING FROM THE RIGHTS OF THE

PUBLIC OR RIPARIAN OWNERS TO USE ANY PORTION WHICH IS NOW

16. PARAMOUNT RIGHTS AND EASEMENTS IN FAVOR OF THE UNITED STATES FOR COMMERCE, NAVIGATION, FISHERIES AND THE PRODUCTION OF POWER.

(NOT PLOTTED, BLANKET IN NATURE)

BASIS OF BEARINGS

A BEARING OF N 88°52'01" W BETWEEN FOUND SURVEY POINTS ON THE NORTH LINE OF R1.

REFERENCES

R1. CROWDER ADDITION, VOL.17, PG. 90&91 R2. ROS VOL.61, PG.260

R3. ROS VOL.182, PG. 242

VERTICAL DATUM

NAVD88 PER CITY OF MERCER ISLAND BENCHMARK 2220


SURVEYOR'S NOTES

- . THE TOPOGRAPHIC SURVEY SHOWN HEREON WAS PERFORMED IN OCTOBER OF 2020. THE FIELD DATA WAS COLLECTED AND RECORDED ON MAGNETIC MEDIA THROUGH AN ELECTRONIC THEODOLITE. THE DATA FILE IS ARCHIVED ON DISC OR CD. WRITTEN FIELD NOTES MAY NOT EXIST. CONTOURS ARE SHOWN FOR CONVENIENCE ONLY. DESIGN SHOULD RELY ON SPOT
- 2. ALL MONUMENTS SHOWN HEREON WERE LOCATED DURING THE COURSE OF THIS SURVEY UNLESS OTHERWISE NOTED.
- 3. THE TYPES AND LOCATIONS OF ANY UTILITIES SHOWN ON THIS DRAWING ARE BASED ON INFORMATION PROVIDED TO US, BY OTHERS OR GENERAL INFORMATION READILY AVAILABLE IN THE PUBLIC DOMAIN INCLUDING, AS APPLICABLE, IDENTIFYING MARKINGS PLACED BY UTILITY LOCATE SERVICES AND OBSERVED BY TERRANE IN THE FIELD. AS SUCH, THE UTILITY INFORMATION SHOWN ON THESE DRAWINGS ARE FOR INFORMATIONAL PURPOSES ONLY AND SHOULD NOT BE RELIED ON FOR DESIGN OR CONSTRUCTION PURPOSES; TERRANE IS NOT RESPONSIBLE OR LIABLE FOR THE ACCURACY OR COMPLETENESS OF THIS UTILITY INFORMATION. FOR THE ACCURATE LOCATION AND TYPE OF UTILITIES NECESSARY FOR DESIGN AND CONSTRUCTION, PLEASE CONTACT THE SITE OWNER AND THE LOCAL UTILITY LOCATE SERVICE (800-424-5555).
- 4. SUBJECT PROPERTY TAX PARCEL NO.(S)1824059108 & 1824059113 5. SUBJECT PROPERTY AREA PER THIS SURVEY IS 25,423 S.F. (0.58 ACRES) PARCEL NO. 1824059108 1/10TH INTEREST ROAD TRACT


SUBJECT PROPERTY AREA PER THIS SURVEY IS 16,878 S.F. (0.39 ACRES) PARCEL NO. 1824059113

- 6. THE PROPERTY DESCRIBED HEREON IS THE SAME AS THE PROPERTY DESCRIBED IN CHICAGO TITLE INSURANCE COMPANY, CERTIFICATE NO. 0154971—ETU, WITH AN EFFECTIVE DATE OF JULY 15, 2019 AND THAT ALL EASEMENTS, COVENANTS AND RESTRICTIONS REFERENCED IN SAID TITLE COMMITMENT OR APPARENT FROM A PHYSICAL INSPECTION OF THE PROPERTY OR OTHERWISE KNOWN TO ME HAVE BEEN PLOTTED HEREON OR OTHERWISE NOTED AS TO THEIR EFFECT ON THE PROPERTY.
- 7. FIELD DATA FOR THIS SURVEY WAS OBTAINED BY DIRECT FIELD MEASUREMENTS WITH A CALIBRATED ELECTRONIC 5-SECOND TOTAL STATION AND/OR SURVEY GRADE GPS OBSERVATIONS. ALL ANGULAR AND LINEAR RELATIONSHIPS ARE ACCURATE AND MEET THE STANDARDS SET BY WAC 332-130-090.

LEGEND

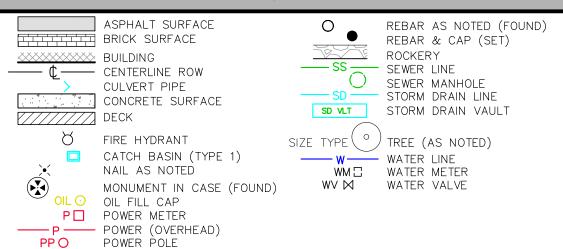

VICINITY MAP Mercer Island Beach Park Open Space Herzl-Ner Tamid Privett Academy Conservative... Yellow Wood Academy School of Puget Sound Mercerwood Shore Club

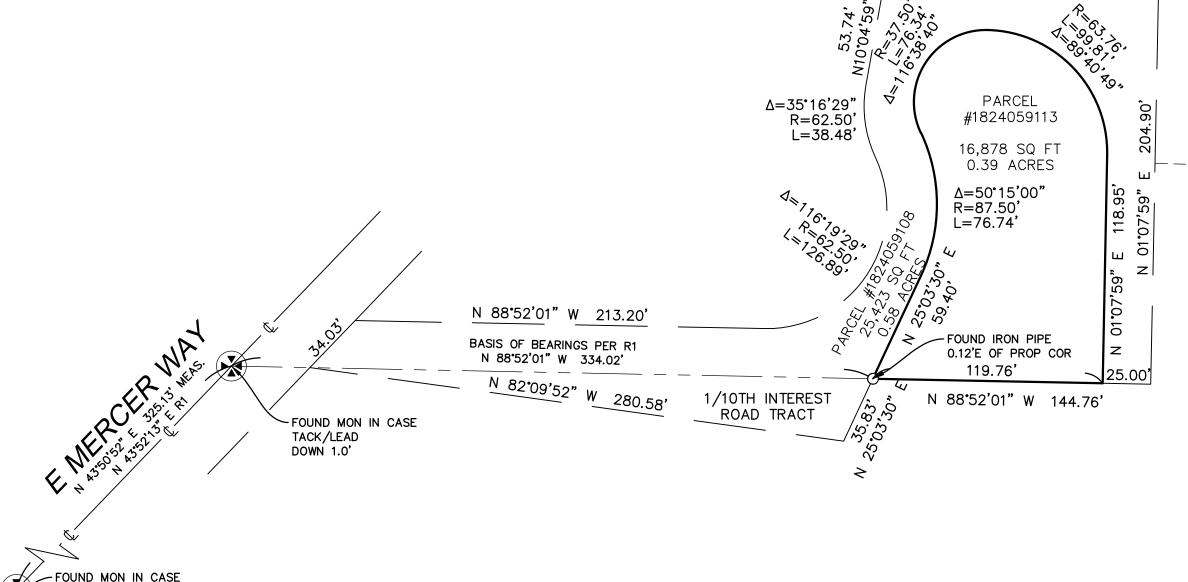


CONTROL MAP

N.T.S.

STEEP SLOPE/BUFFER DISCLAIMER:

TACK/LEAD

THE LOCATION AND EXTENT OF STEEP SLOPES SHOWN ON THIS DRAWING ARE FOR INFORMATIONAL PURPOSES ONLY AND CANNOT BE RELIED ON FOR DESIGN AND/OR CONSTRUCTION. THE PITCH, LOCATION, AND EXTENT ARE BASED SOLELY ON OUR GENERAL OBSERVATIONS ON SITE AND OUR CURSORY REVIEW OF READILY AVAILABLE PUBLIC DOCUMENTS; AS SUCH, TERRANE CANNOT BE LIABLE OR RESPONSIBLE FOR THE ACCURACY OR COMPLETENESS OF ANY STEEP SLOPE INFORMATION. ULTIMATELY THE LIMITS AND EXTENT OF ANY STEEP SLOPES ASSOCIATED WITH ANY SETBACKS OR OTHER DESIGN OR CONSTRUCTION PARAMETERS MUST BE DISCUSSED AND APPROVED BY THE REVIEWING AGENCY BEFORE ANY CONSTRUCTION CAN OCCUR.

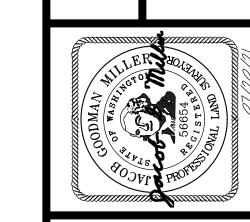

11/04/20 TMM/JGM

N 88°31'51" W 143.01'


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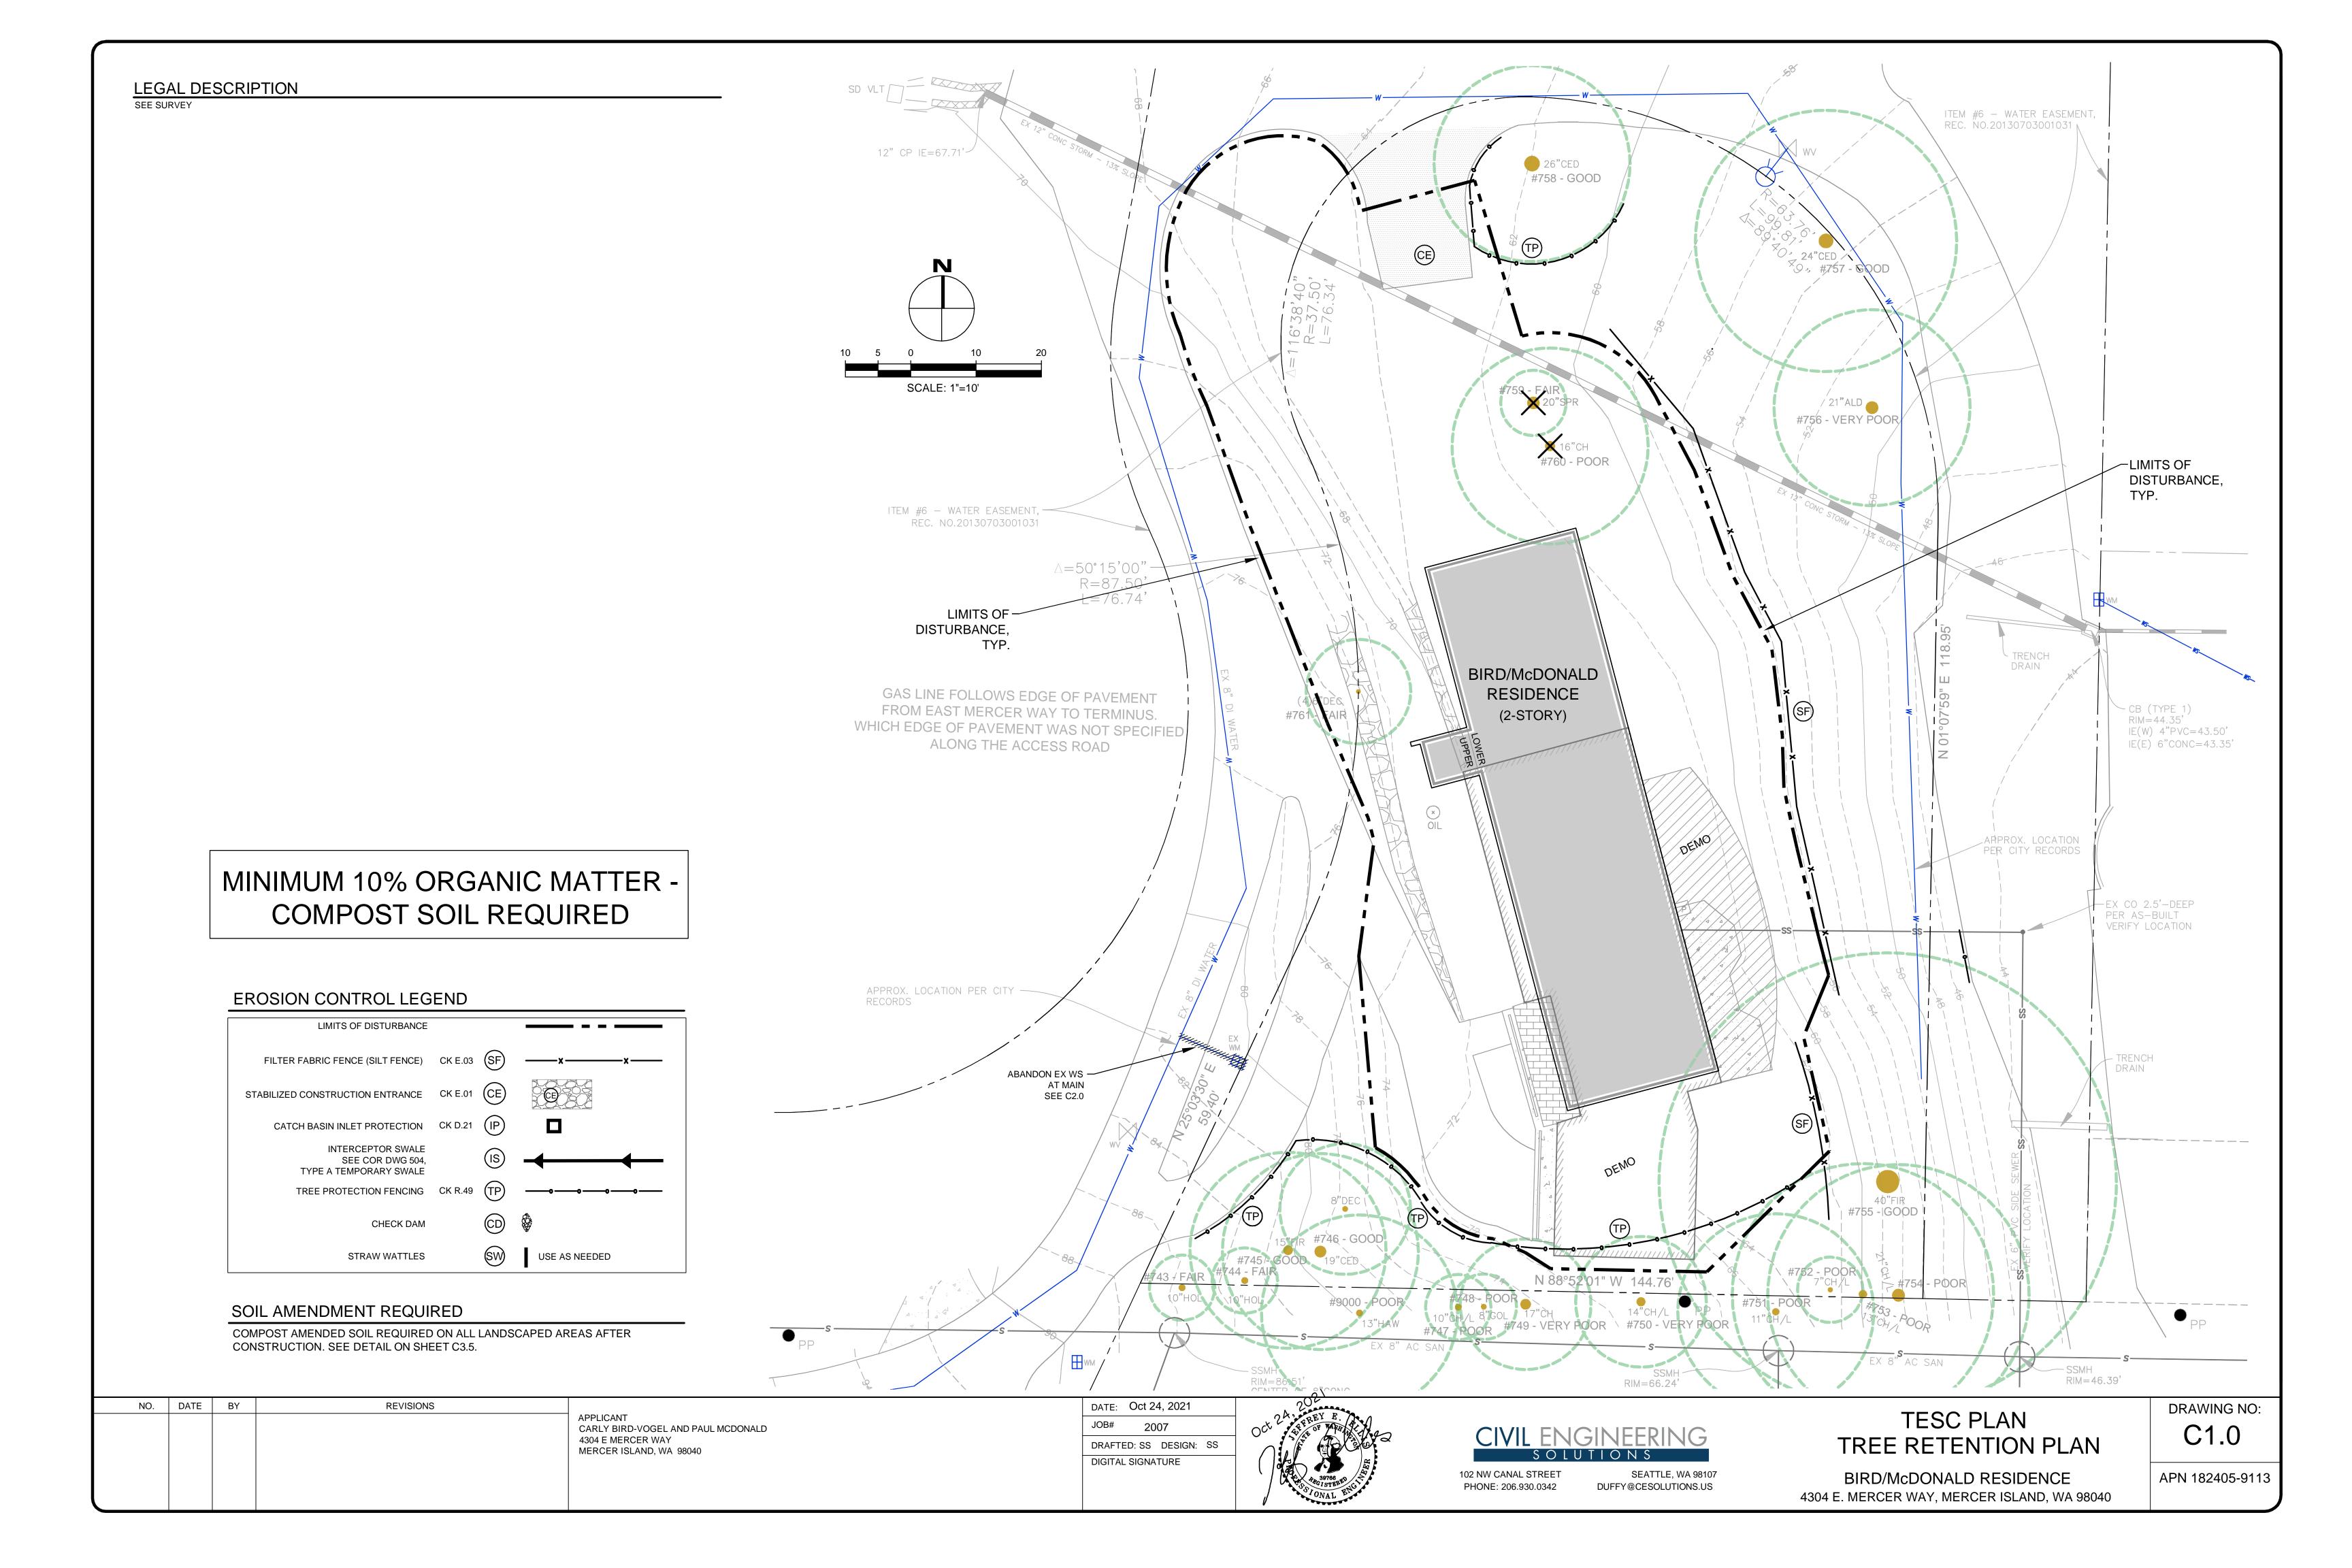
JOB NUMBER: DRAFTED BY: CHECKED BY:

REVISION HISTORY 07/20/21 TREE REMOVAL

SHEET NUMBER

1 OF 2




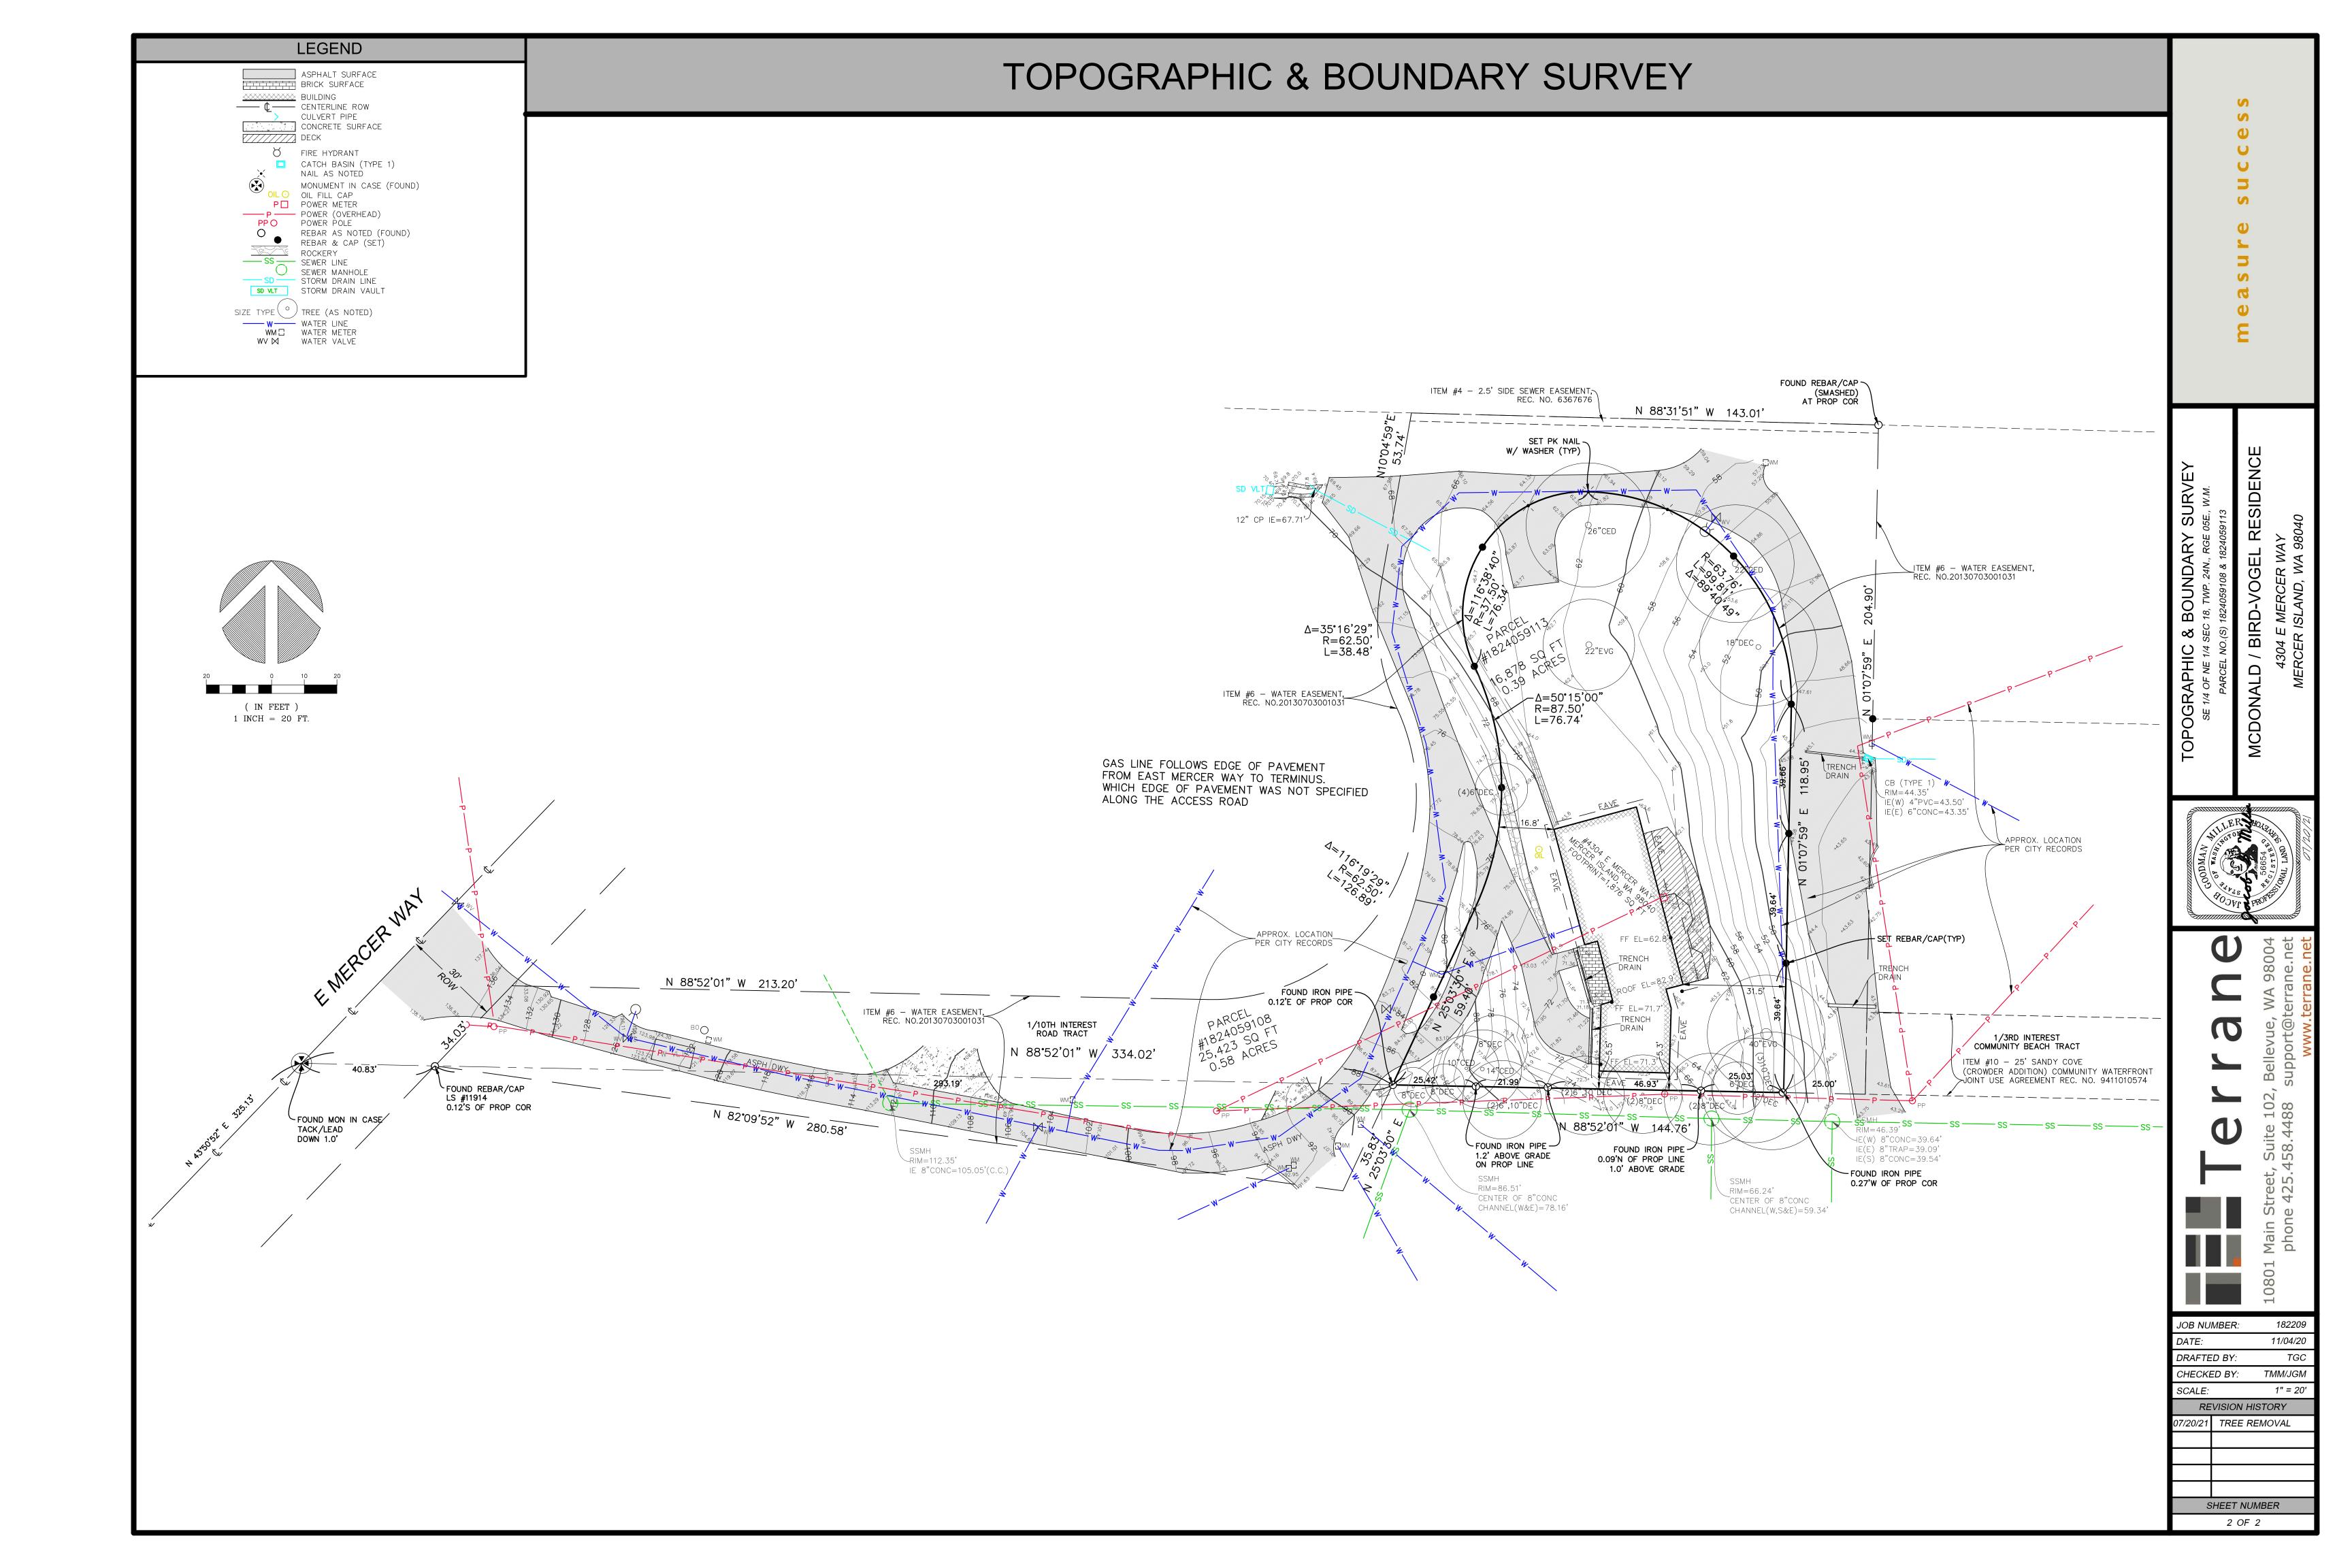

2019 Stormwater Management Manual for Western Washington
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CONSTRUCTION ENTRANCE

DOE

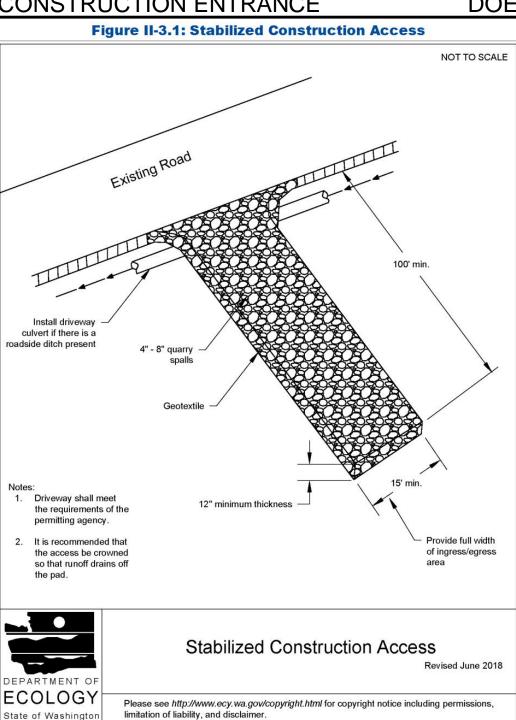

2019 Stormwater Management Manual for Western Washington
Volume II - Chapter 3 - Page 279

RECOMMENDED CONSTRUCTION SEQUENCE

A DETAILED CONSTRUCTION SEQUENCE IS NEEDED TO ENSURE THAT EROSION AND SEDIMENT CONTROL MEASURES ARE APPLIED AT THE APPROPRIATE TIMES. A RECOMMENDED CONSTRUCTION SEQUENCE IS PROVIDED BELOW:

1. HOLD AN ONSITE PRE-CONSTRUCTION MEETING.

2. POST SIGN WITH NAME AND PHONE NUMBER OF ESC SUPERVISOR (MAY BE CONSOLIDATED WITH THE REQUIRED NOTICE OF CONSTRUCTION SIGN).

3. FLAG OR FENCE CLEARING LIMITS.

4. INSTALL CATCH BASIN PROTECTION, IF REQUIRED.

5. GRADE AND INSTALL CONSTRUCTION ENTRANCE(S).

6. INSTALL PERIMETER PROTECTION (SILT FENCE, BRUSH BARRIER, ETC.).

7. CONSTRUCT SEDIMENT PONDS AND TRAPS.

8. GRADE AND STABILIZE CONSTRUCTION ROADS.

9. CONSTRUCT SURFACE WATER CONTROLS (INTERCEPTOR DIKES, PIPE SLOPE DRAINS, ETC.) SIMULTANEOUSLY WITH CLEARING AND GRADING FOR PROJECT DEVELOPMENT.

10. MAINTAIN EROSION CONTROL MEASURES IN ACCORDANCE WITH CITY OF MERCER ISLAND STANDARDS AND MANUFACTURER'S RECOMMENDATIONS.

11. RELOCATE SURFACE SURFACE WATER CONTROLS OR TESC MEASURES, OR INSTALL NEW MEASURES SO THAT AS SITE CONDITIONS CHANGE, THE TESC IS ALWAYS IN ACCORDANCE WITH CITY OF MERCER ISLAND TESC REQUIREMENTS.

12. COVER ALL AREAS THAT WILL BE UN-WORKED FOR MORE THAN SEVEN DAYS DURING THE DRY SEASON (MAY 1 TO SEPT 30) OR TWO DAYS DURING THE WET SEASON (OCT 1 TO APRIL 30) WITH STRAW, WOOD FIBER MULCH, COMPOST, PLASTIC SHEETING, OR EQUIVALENT.

13. STABILIZE ALL AREAS WITHIN SEVEN DAYS OF REACHING FINAL GRADE.

14. SEED, SOD, STABILIZE, OR COVER ANY AREAS TO REMAIN UNWORKED FOR MORE THAN 30 DAYS.

15. UPON COMPLETION OF THE PROJECT, STABILIZE ALL DISTURBED AREAS AND REMOVE BMPS IF APPROPRIATE.

DENUDED AREAS REQUIREMENTS

APRIL 1 TO SEPT 30

ALL DENUDED AREAS MUST BE STABILIZED WITHIN 7 DAYS OF CONSTRUCTION. PLEASE READ ALL CITY TESC NOTES ON SHEET C1.2.

OCT 1 TO MARCH 31

ALL DENUDED AREAS MUST BE STABILIZED WITHIN 2 DAYS OF GRADING. IF AN EROSION PROBLEM ALREADY EXISTS ON THE SITE, OTHER COVER PROTECTION AND EROSION CONTROL WILL BE REQUIRED.

EROSION CONTROL NOTES

D.8.2 STANDARD ESC PLAN NOTES

THE STANDARD ESC PLAN NOTES MUST BE INCLUDED ON ALL ESC PLANS. AT THE APPLICANT'S DISCRETION, NOTES THAT IN NO WAY APPLY TO THE PROJECT MAY BE OMITTED; HOWEVER, THE REMAINING NOTES MUST NOT BE RENUMBERED. FOR EXAMPLE, IF ESC NOTE #3 WERE OMITTED, THE REMAINING NOTES SHOULD BE NUMBERED 1, 2, 4, 5, 6, ETC.

1. APPROVAL OF THIS EROSION AND SEDIMENTATION CONTROL (ESC) PLAN DOES NOT CONSTITUTE AN APPROVAL OF PERMANENT ROAD OR DRAINAGE DESIGN (E.G., SIZE AND LOCATION OF ROADS, PIPES, RESTRICTORS, CHANNELS, RETENTION FACILITIES, UTILITIES, ETC.).

2. THE IMPLEMENTATION OF THESE ESC PLANS AND THE CONSTRUCTION, MAINTENANCE, REPLACEMENT, AND UPGRADING OF THESE ESC FACILITIES IS THE RESPONSIBILITY OF THE APPLICANT/ESC SUPERVISOR UNTIL ALL CONSTRUCTION IS APPROVED.

3. THE BOUNDARIES OF THE CLEARING LIMITS SHOWN ON THIS PLAN SHALL BE CLEARLY FLAGGED BY SURVEY TAPE OR FENCING, IF REQUIRED, PRIOR TO CONSTRUCTION (SWDM APPENDIX D). DURING THE CONSTRUCTION PERIOD, NO DISTURBANCE BEYOND THE CLEARING LIMITS SHALL BE PERMITTED. THE CLEARING LIMITS SHALL BE MAINTAINED BY THE APPLICANT/ESC SUPERVISOR FOR THE DURATION OF CONSTRUCTION.

4. STABILIZED CONSTRUCTION ENTRANCES SHALL BE INSTALLED AT THE BEGINNING OF CONSTRUCTION AND MAINTAINED FOR THE DURATION OF THE PROJECT. ADDITIONAL MEASURES, SUCH AS CONSTRUCTED WHEEL WASH SYSTEMS OR WASH PADS, MAY BE REQUIRED TO ENSURE THAT ALL PAVED AREAS ARE KEPT CLEAN AND TRACK OUT TO ROAD RIGHT OF WAY DOES NOT OCCUR FOR THE DURATION OF THE PROJECT.

5. THE ESC FACILITIES SHOWN ON THIS PLAN MUST BE CONSTRUCTED PRIOR TO OR IN CONJUNCTION WITH ALL CLEARING AND GRADING SO AS TO ENSURE THAT THE TRANSPORT OF SEDIMENT TO SURFACE WATERS, DRAINAGE SYSTEMS, AND ADJACENT PROPERTIES IS MINIMIZED.

6. THE ESC FACILITIES SHOWN ON THIS PLAN ARE THE MINIMUM REQUIREMENTS FOR ANTICIPATED SITE CONDITIONS. DURING THE CONSTRUCTION PERIOD, THESE ESC FACILITIES SHALL BE UPGRADED AS NEEDED FOR UNEXPECTED STORM EVENTS AND MODIFIED TO ACCOUNT FOR CHANGING SITE CONDITIONS (E.G. ADDITIONAL COVER MEASURES, ADDITIONAL SUMP PUMPS, RELOCATION OF DITCHES AND SILT FENCES, PERIMETER PROTECTION ETC.) AS DIRECTED BY CITY OF MERCER ISLAND.

7. THE ESC FACILITIES SHALL BE INSPECTED DAILY BY THE APPLICANT/ESC SUPERVISOR AND MAINTAINED TO ENSURE CONTINUED PROPER FUNCTIONING. WRITTEN RECORDS SHALL BE KEPT OF WEEKLY REVIEWS OF THE ESC FACILITIES.

8. ANY AREAS OF EXPOSED SOILS, INCLUDING ROADWAY EMBANKMENTS, THAT WILL NOT BE DISTURBED FOR TWO CONSECUTIVE DAYS DURING THE WET SEASON OR SEVEN DAYS DURING THE DRY SEASON SHALL BE IMMEDIATELY STABILIZED WITH THE APPROVED ESC METHODS (E.G., SEEDING, MULCHING, PLASTIC COVERING, ETC.).

9. ANY AREA NEEDING ESC MEASURES THAT DO NOT REQUIRE IMMEDIATE ATTENTION SHALL BE ADDRESSED WITHIN SEVEN (7) DAYS.

10. THE ESC FACILITIES ON INACTIVE SITES SHALL BE INSPECTED AND MAINTAINED A MINIMUM OF ONCE A MONTH DURING THE DRY SEASON, BI-MONTHLY DURING THE WET SEASON, OR WITHIN TWENTY FOUR (24) HOURS FOLLOWING A STORM EVENT.

11. AT NO TIME SHALL MORE THAN ONE (1) FOOT OF SEDIMENT BE ALLOWED TO ACCUMULATE WITHIN A CATCH BASIN. ALL CATCH BASINS AND CONVEYANCE LINES SHALL BE CLEANED PRIOR TO PAVING. THE CLEANING OPERATION SHALL NOT FLUSH SEDIMENT-LADEN WATER INTO THE DOWNSTREAM SYSTEM.

12. ANY PERMANENT RETENTION/DETENTION FACILITY USED AS A TEMPORARY SETTLING BASIN SHALL BE MODIFIED WITH THE NECESSARY EROSION CONTROL MEASURES AND SHALL PROVIDE ADEQUATE STORAGE CAPACITY. IF THE FACILITY IS TO FUNCTION ULTIMATELY AS AN INFILTRATION SYSTEM, THE TEMPORARY FACILITY MUST BE ROUGH GRADED SO THAT THE BOTTOM AND SIDES ARE AT LEAST THREE FEET ABOVE THE FINAL GRADE OF THE PERMANENT FACILITY.

13. COVER MEASURES WILL BE APPLIED IN CONFORMANCE WITH APPENDIX D OF THE SURFACE WATER DESIGN MANUAL


14. PRIOR TO THE BEGINNING OF THE WET SEASON (OCT. 1), ALL DISTURBED AREAS SHALL BE REVIEWED TO IDENTIFY WHICH ONES CAN BE SEEDED IN PREPARATION FOR THE WINTER RAINS. DISTURBED AREAS SHALL BE SEEDED WITHIN ONE WEEK OF THE BEGINNING OF THE WET SEASON.

CITY NOTES

- 1. ANY CHANGES TO THE APPROVED PLANS REQUIRES CITY APPROVAL THROUGH A REVISION.
- 2. APPLICANT IS RESPONSIBLE FOR ANY DAMAGES TO UNDERGROUND UTILITIES CAUSED FROM THIS CONSTRUCTION.
- 3. CATCH BASIN FILTERS SHOULD BE PROVIDED FOR ALL STORM DRAIN CATCH BASINS/INLETS DOWNSLOPE AND WITHIN 500 FEET OF THE CONSTRUCTION AREA. CATCH BASIN FILTERS SHOULD BE DESIGNED BY THE MANUFACTURER FOR USE AT CONSTRUCTION SITES AND APPROVED BY THE CITY INSPECTOR. CATCH BASIN FILTERS SHOULD BE INSPECTED FREQUENTLY, ESPECIALLY AFTER STORM EVENTS. IF THE FILTER BECOMES CLOGGED, IT SHOULD BE CLEANED OR REPLACED.
- 4. CONTRACTORS SHALL VERIFY LOCATIONS AND DEPTHS OF UTILITES.
- 5. AT LEAST 48 HOURS PRIOR TO CONSTRUCTION, CALL "ONE CALL" AT 1.800.424.5555
- 6. DO NOT BACKFILL WITH NATIVE MATERIAL ON PUBLIC RIGHT-OF-WAY. ALL MATERIAL MUST BE IMPORTED
- 7. EROSION CONTROL: ALL "LAND DISTURBING ACTIVITY" IS SUBJECT TO PROVISIONS OF MERCER ISLAND ORDINANCE 95C-118 "STORM WATER MANAGEMENT." SPECIFIC ITEMS TO BE FOLLOWED AT YOUR SITE:
- 8. PROTECT ADJACENT PROPERTIES FROM ANY INCREASED RUNOFF OR SEDIMENTATION DUE TO THE CONSTRUCTION PROJECT THROUGH THE USE OF APPROPRIATE "BEST MANAGEMENT PRACTICES" (BMP) EXAMPLES INCLUDE, BUT ARE NOT LIMITED TO, SEDIMENT TRAPS, SEDIMENT PONDS, FILTER FABRIC FENCES, VEGETATIVE BUFFER STRIPS OR BIOENGINEERED SWALES.
- 9. CONSTRUCTION ACCESS TO THE SITE SHOULD BE LIMITED TO ONE ROUTE. STABILIZE ENTRANCE WITH QUARRY SPALLS TO PREVENT SEDIMENT FROM LEAVING THE SITE OR ENTERING THE STORM DRAINS.
- 10. PREVENT SEDIMENT, CONSTRUCTION DEBRIS, PAINTS, SOLVENTS, ETC., OR OTHER TYPES OF POLLUTION FROM ENTERING PUBLIC STORM DRAINS. KEEP ALL POLLUTION ON YOUR SITE.
- 11. ALL EXPOSED SOILS SHALL REMAIN DENUDED FOR NO LONGER THAN SEVEN (7) DAYS AND SHALL BE STABILIZED WITH MULCH, HAY, OR THE APPROPRIATE GROUND COVER. ALL EXPOSED SOILS SHALL BE COVERED IMMEDIATELY DURING ANY RAIN EVENT.
- 12. INSTALLATION OF CONCRETE DRIVEWAYS, TREES, SHRUBS, IRRIGATION, BOULDERS, BERMS, WALLS, GATES, AND OTHER IMPROVEMENTS ARE NOT ALLOWED IN THE PUBLIC RIGHT-OF-WAY WITHOUT PRIOR APPROVAL, AND AN ENCROACHMENT AGREEMENT AND RIGHT OF WAY PERMIT FROM THE SENIOR DEVELOPMENT ENGINEER.
- 13. OWNER SHALL CONTROL DISCHARGE OF SURFACE DRAINAGE RUNOFF FROM EXISTING AND NEW IMPERVIOUS AREAS IN A RESPONSIBLE MANNER. CONSTRUCTION OF NEW GUTTERS AND DOWNSPOUTS, DRY WELLS, LEVEL SPREADERS OR DOWNSTREAM CONVEYANCE PIPE MAY BE NECESSARY TO MINIMIZE DRAINAGE IMPACT TO YOUR NEIGHBORS. CONSTRUCTION OF MINIMUM DRAINAGE IMPROVEMENTS SHOWN OR CALLED OUT ON THIS PLAN DOES NOT IMPLY RELIEF FROM CIVIL LIABILITY FOR YOUR DOWNSTREAM DRAINAGE.
- 14. POT HOLING THE PUBLIC UTILITIES IS REQUIRED PRIOR TO ANY GRADING ACTIVITIES LESS THAN 6" OVER THE PUBLIC MAINS (WATER, SEWER AND STORM SYSTEMS). IF THERE IS A CONFLICT, THE APPLICANT IS REQUIRED TO SUBMIT A REVISION FOR APPROVAL PRIOR TO ANY GRADING ACTIVITIES OVER THE PUBLIC MAINS.
- 15. REMEMBER: EROSION CONTROL IS YOUR FIRST INSPECTION.
- 16. ROOF DRAINS MUST BE CONNECTED TO THE STORM DRAIN SYSTEM AND INSPECTED BY THE PUBLIC WORKS DEPARTMENT PRIOR TO ANY BACKFILLING OF PIPE.
- 17. SILENT FENCE: CLEAN AND PROVIDE REGULAR MAINTENANCE OF THE SILT FENCE. THE FENCE IS TO REMAIN VERTICAL AND IS TO FUNCTION PROPERLY THROUGHOUT THE TERM OF THE PROJECT.
- 18. WORK IN PUBLIC RIGHT OF WAY REQUIRES A RIGHT-OF-WAY USE PERMIT.
- 19. REFER TO WATER SERVICE PERMIT FOR ACTUAL LOCATION OF NEW WATER METER AND SERVICE LINE DETERMINED BY MERCER ISLAND WATER DEPARTMENT.
- 16. THE TV INSPECTION OF THE EXISTING SIDE SEWER TO THE CITY SEWER MAIN IS REQUIRED. IF THE RESULT OF THE TV INSPECTION IS NOT IN SATISFACTORY CONDITION, AS DETERMINED BY THE CITY OF MERCER ISLAND INSPECTOR, THE REPLACEMENT OF THE EXISTING SIDE SEWER IS REQUIRED. ALTERNATELY, A PRESSURE TEST OF THE SIDE SEWER, FROM SEWER MAIN TO POINT OF CONNECTION, MAY BE SUBSTITUTED FOR THE VIDEO INSPECTION.
- 20. NEWLY INSTALLED SIDE SEWER REQUIRES A 4 P.S.I. AIR TEST OR PROVIDE 10' OF HYDROSTATIC HEAD TEST.
- 21. POT HOLING THE PUBLIC UTILITIES IS REQUIRED PRIOR TO ANY GRADING ACTIVITIES LESS THAN 6" OVER THE PUBLIC MAINS (WATER, SEWER AND STORM SYSTEMS). IF THERE IS A CONFLICT, THE APPLICANT IS REQUIRED TO SUBMIT A REVISION FOR APPROVAL PRIOR TO ANY GRADING ACTIVITIES OVER THE PUBLIC MAINS.
- 22. THE LIMITS AND EXTENDS OF THE PAVEMENT IN THE PUBLIC RIGHT OF WAY SHALL BE DETERMINED BY THE CITY ENGINEER PRIOR TO FINALIZE THE

NO.	DATE	BY	REVISIONS	
				APPLICANT CARLY BIRD-VOGEL AND PAUL MCDONAL 4304 E MERCER WAY MERCER ISLAND, WA 98040



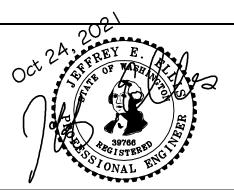




DUFFY@CESOLUTIONS.US

PHONE: 206.930.0342

TESC & CITY NOTES
TESC DETAILS

C1.2

BIRD/McDONALD RESIDENCE 4304 E. MERCER WAY. MERCER ISLAND. WA 98040 APN 182405-9113

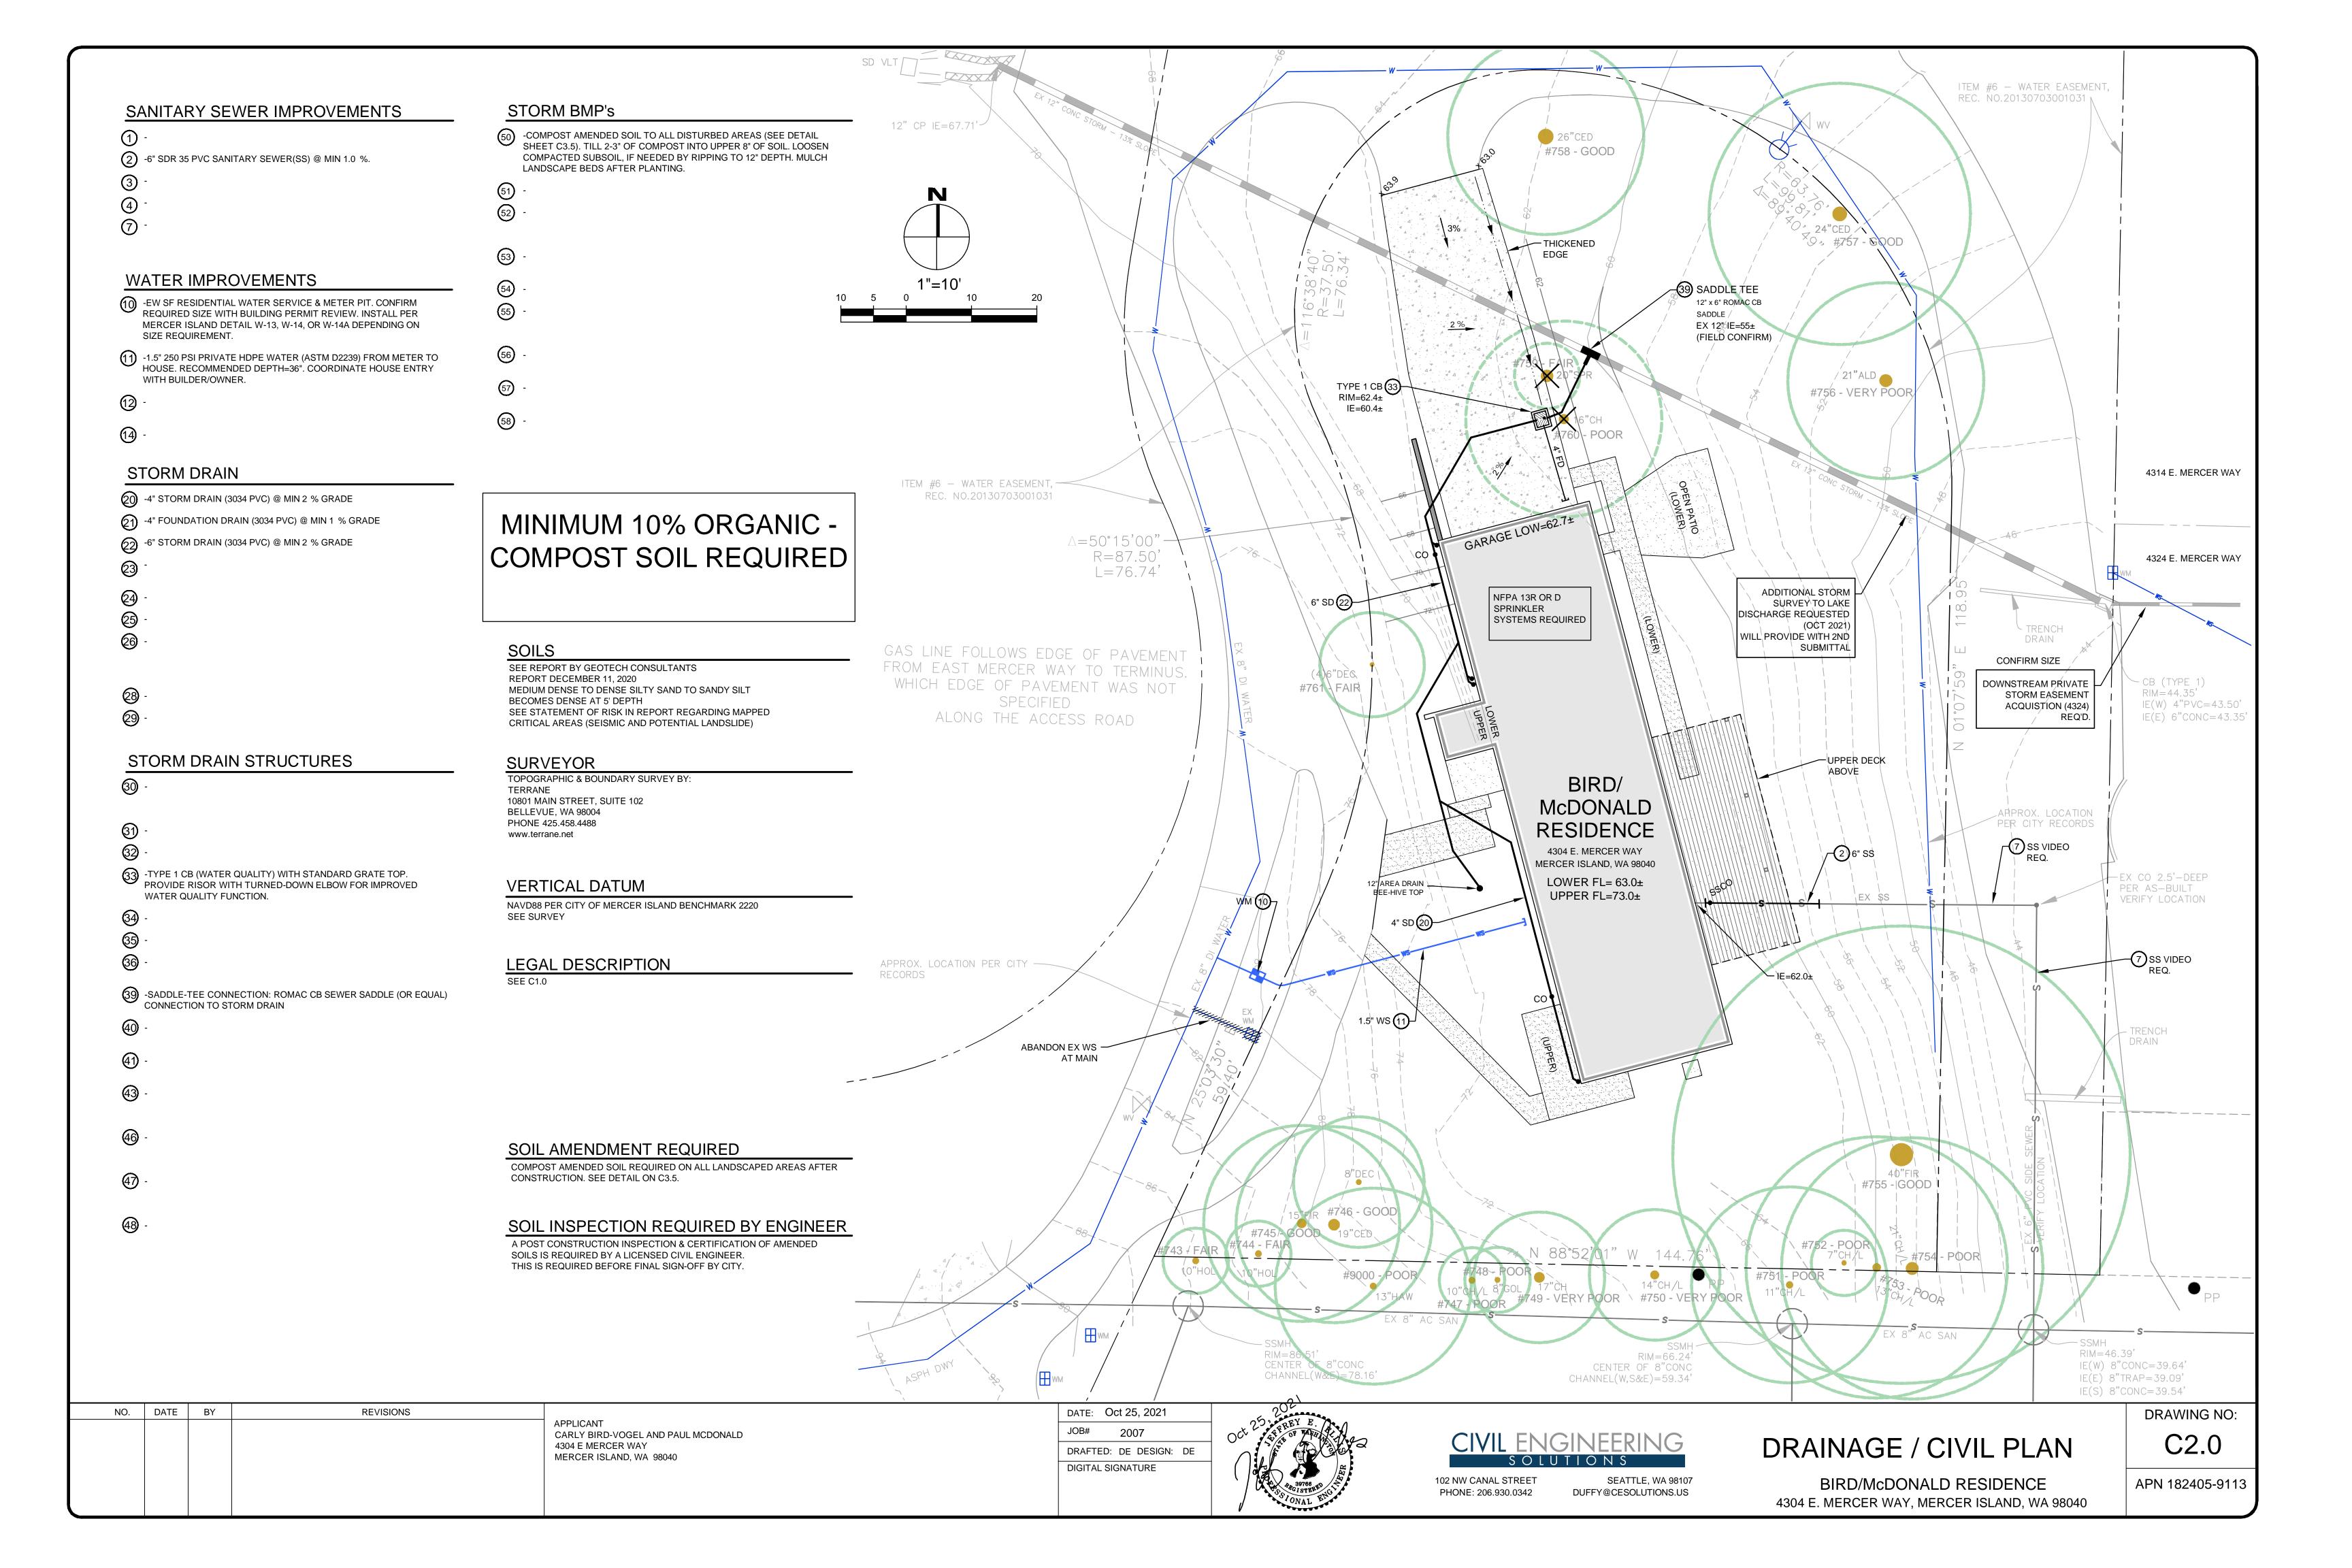

MINIMUM 10% ORGANIC -COMPOST SOIL REQUIRED


SOIL AMENDMENT REQUIRED

COMPOST AMENDED SOIL REQUIRED ON ALL LANDSCAPED AREAS AFTER CONSTRUCTION. SEE DETAIL BELOW.

SOIL INSPECTION REQUIRED BY ENGINEER


A POST CONSTRUCTION INSPECTION & CERTIFICATION OF AMENDED SOILS IS REQUIRED BY A LICENSED CIVIL ENGINEER.
THIS IS REQUIRED BEFORE FINAL SIGN-OFF BY CITY.

COMPOST AMENDED SOIL SPEC

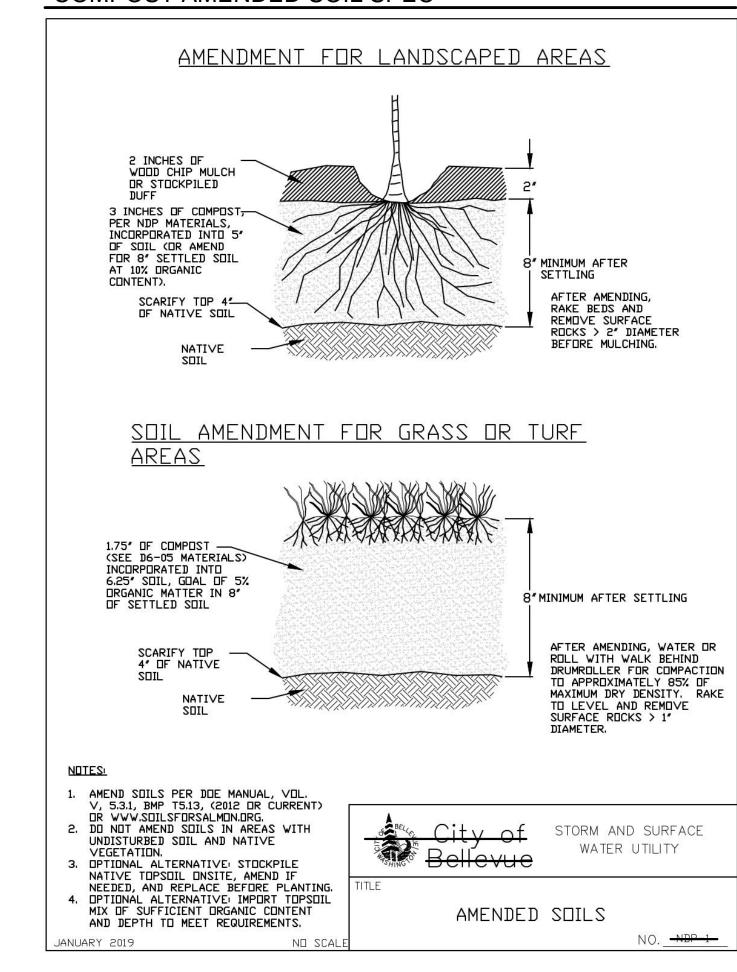

NO.	DATE	BY	REVISIONS	
				APPLICANT CARLY BIRD-VOGEL AND PAUL MCDONALD 4304 E MERCER WAY MERCER ISLAND, WA 98040



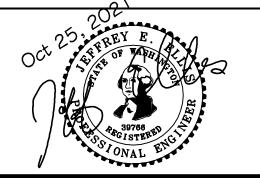




BMP DETAILS

C3.5

DRAWING NO:

4304 E. MERCER WAY, MERCER ISLAND, WA 98040

BIRD/McDONALD RESIDENCE APN 182405-9113

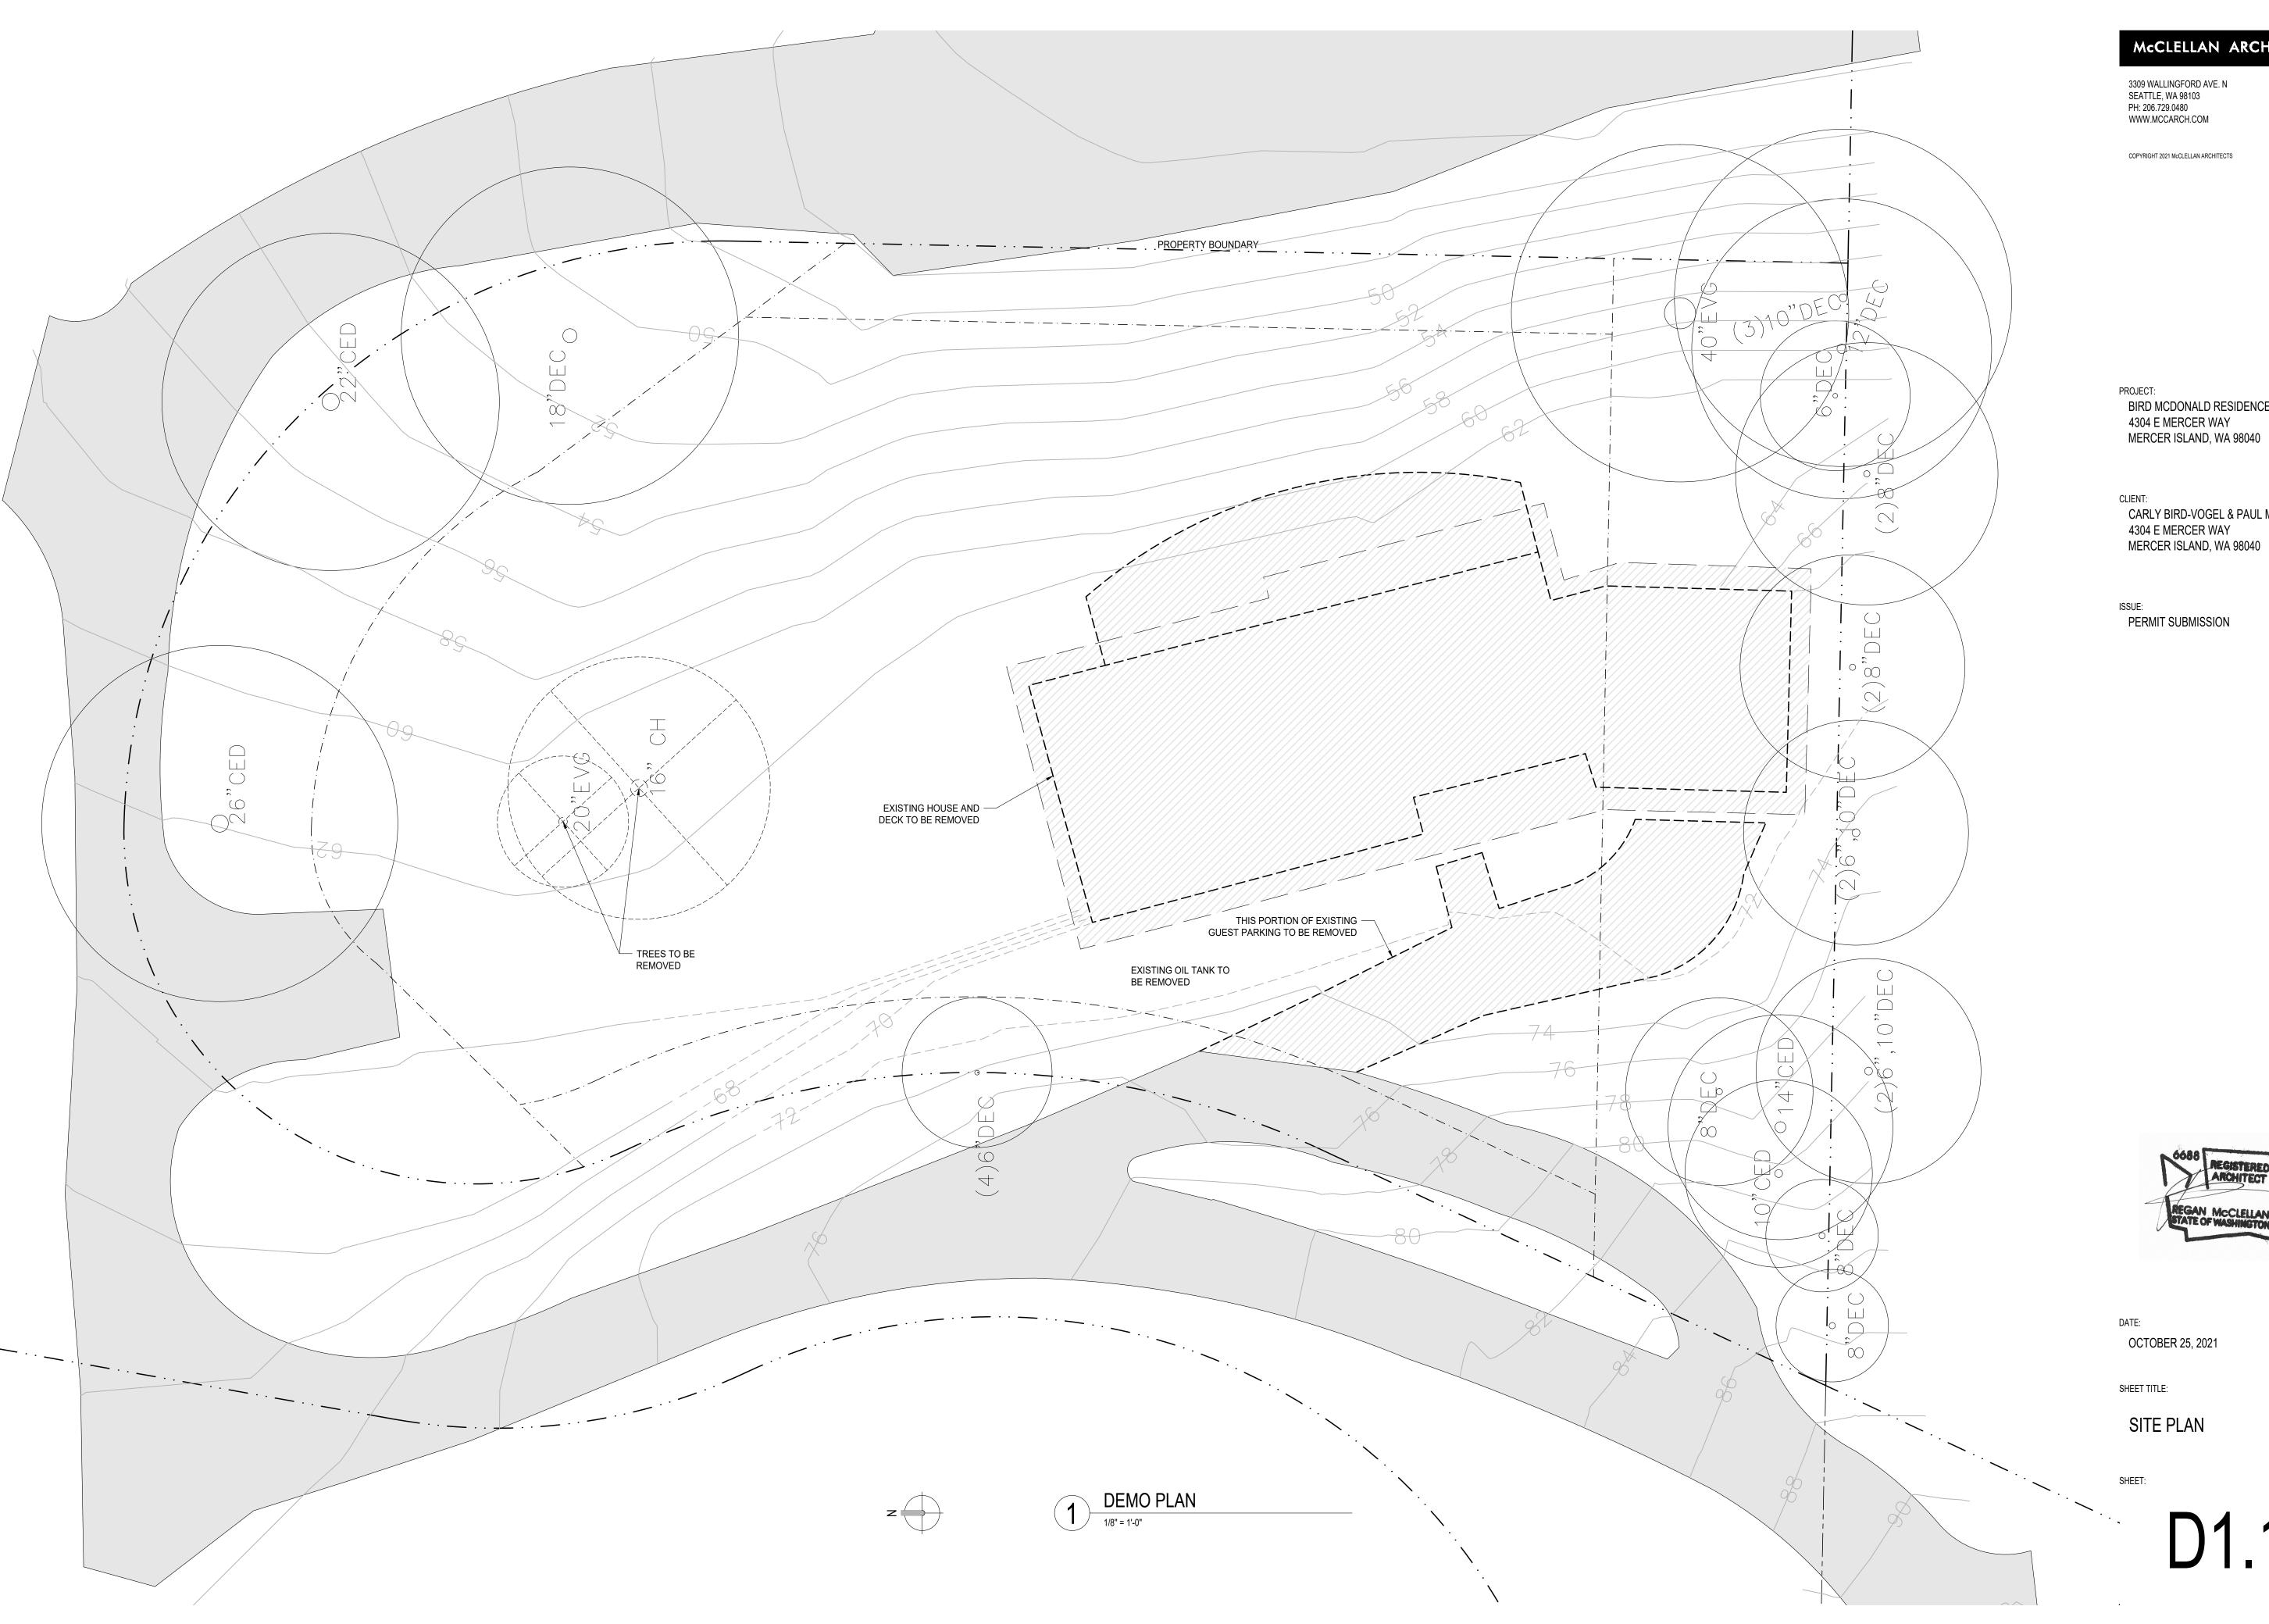

3309 WALLINGFORD AVE. N SEATTLE, WA 98103 PH: 206.729.0480 WWW.MCCARCH.COM

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PROJECT: BIRD MCDONALD RESIDENCE 4304 E MERCER WAY

CLIENT:

CARLY BIRD-VOGEL & PAUL MCDONALD 4304 E MERCER WAY MERCER ISLAND, WA 98040


PERMIT SUBMISSION 2021-10-25





OCTOBER 25, 2021

SHEET TITLE:

SITE PLAN

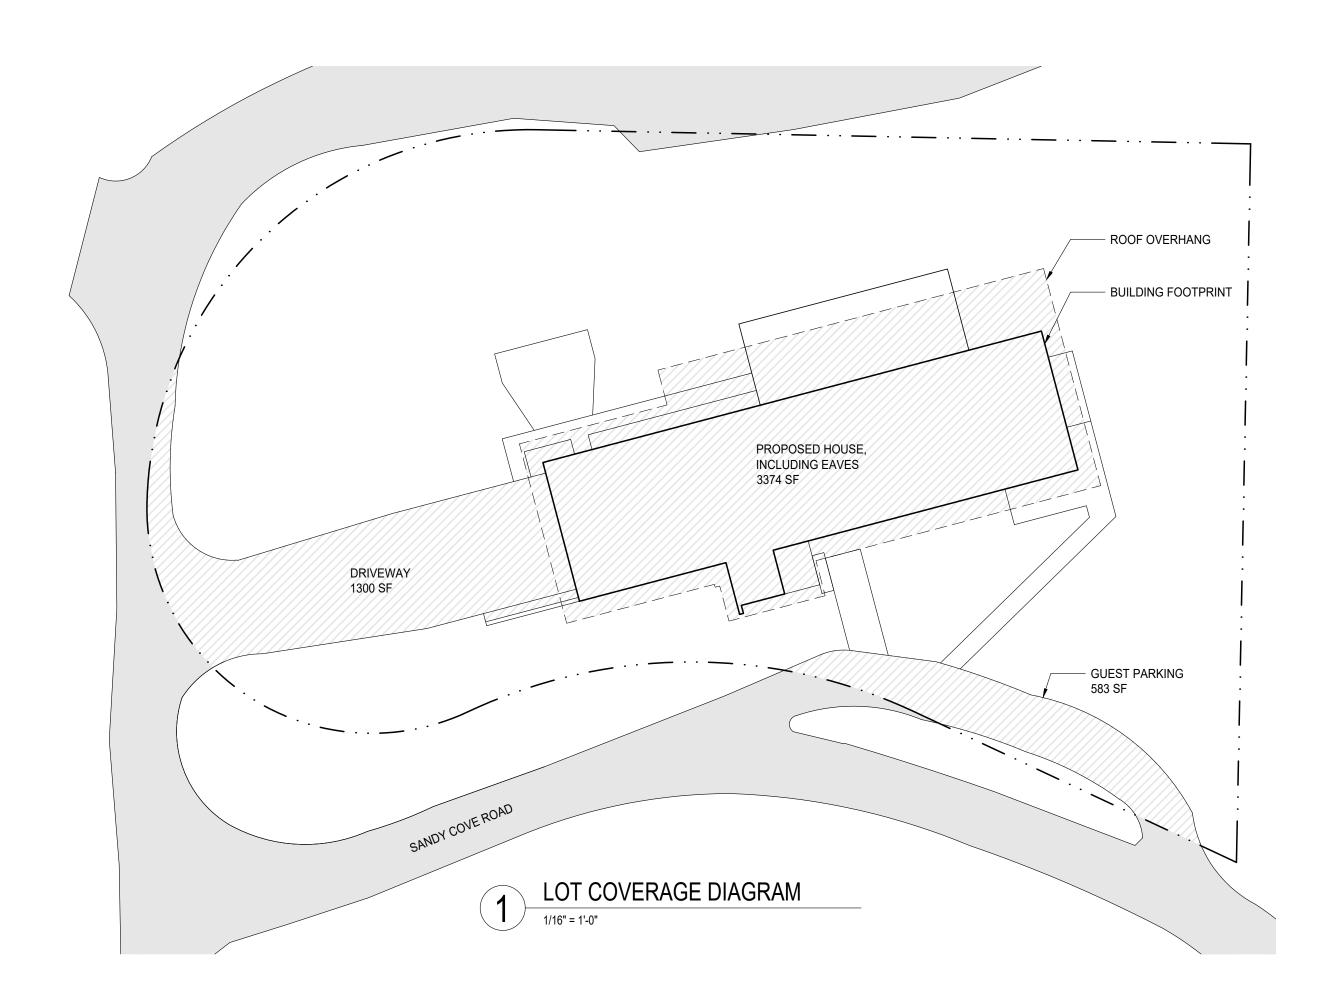

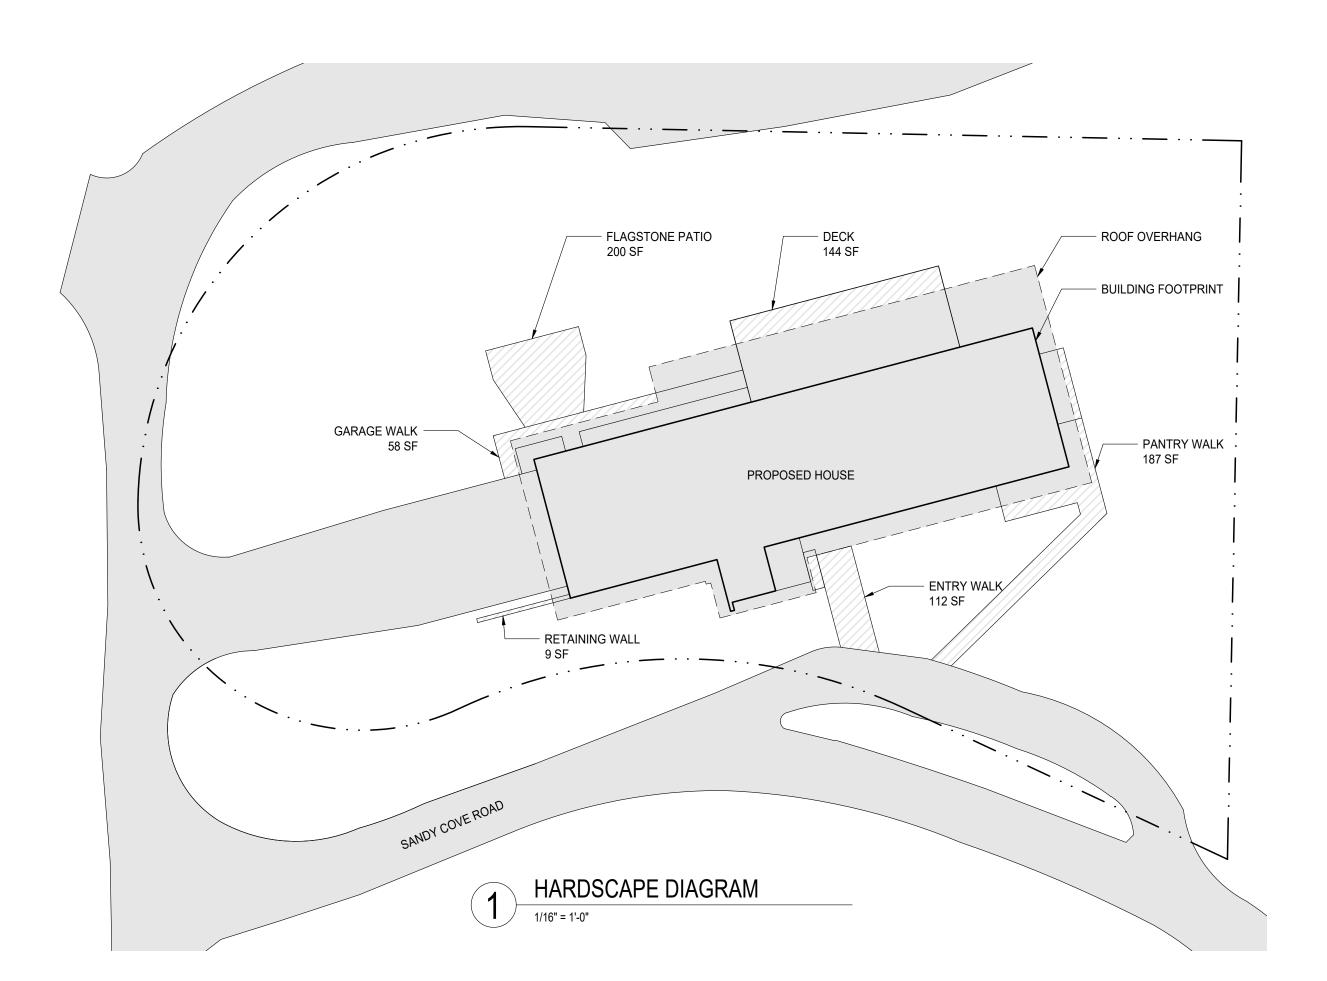

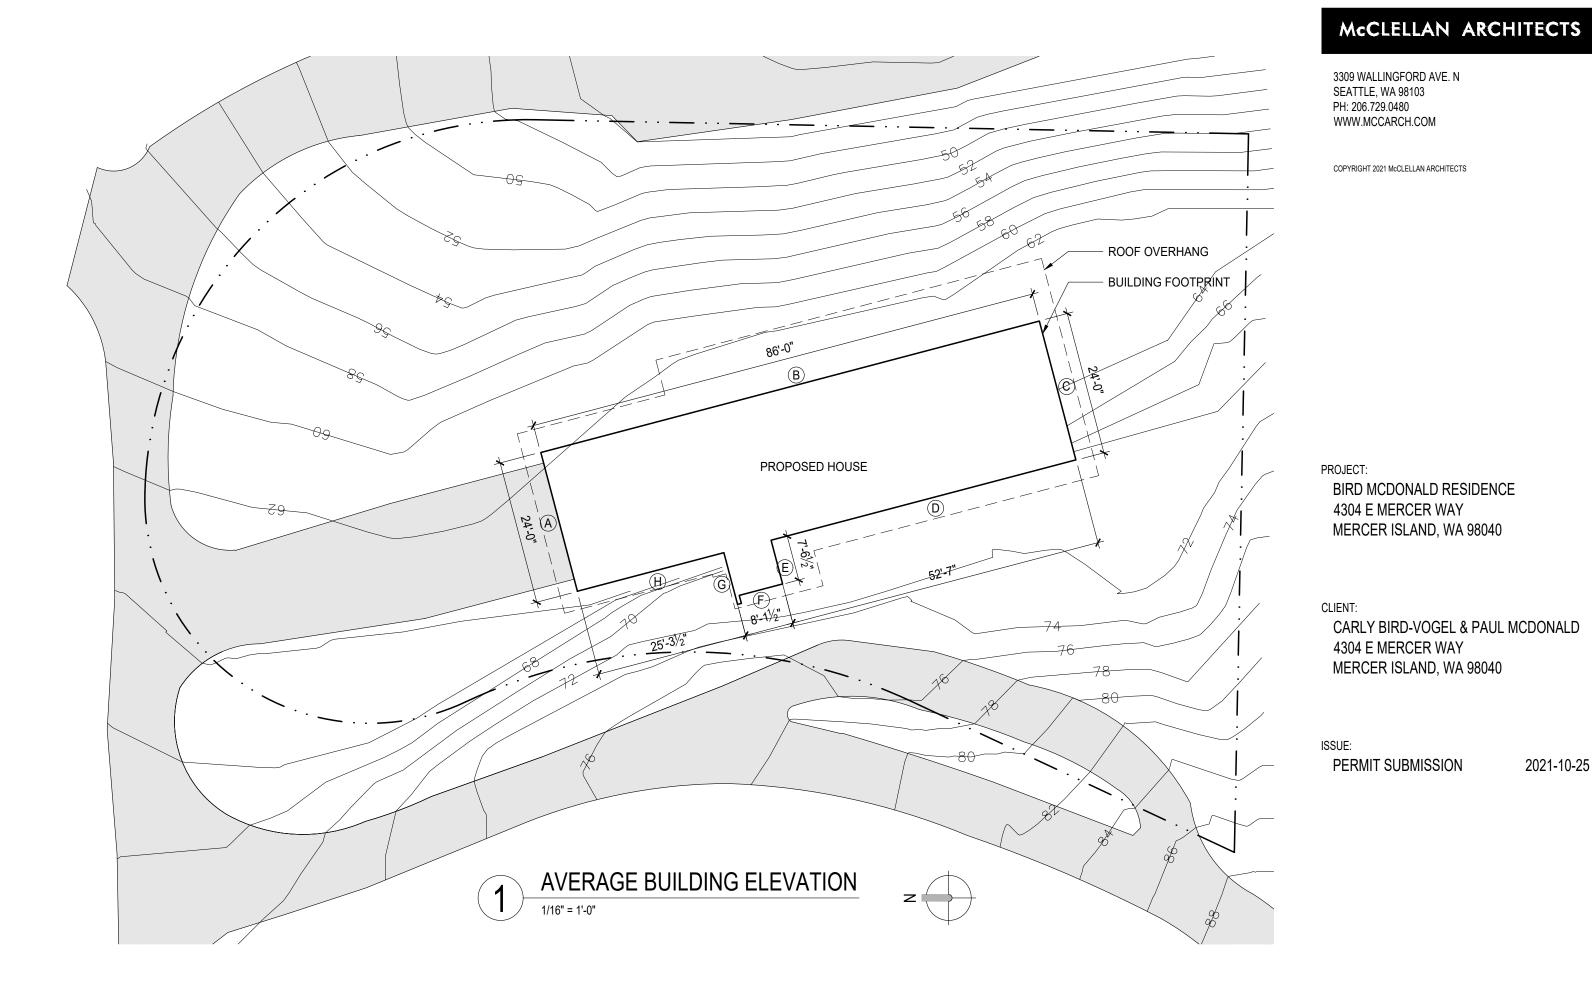

Zoning Calculations

Lot Area 16,878 SF

Gross Floor Area 2,116.0 SF Main Level Floor Area 360.0 SF Main Level Covered Deck 2,476.0 SF 2,060.0 SF Lower Level Floor Area Proposed Gross Floor Area 4,536.0 SF 26.9% Allowable Gross Floor Area 6,751.2 SF 40.0% *Measured from exterior face of building
*Includes attached covered deck floor area

COVERED DECK 360 SF MAIN LEVEL 2116 SF

LOWER LEVEL 2060 SF

GROSS FLOOR AREA DIAGRAM

Lot Slope 29.29% Highest Elevation Point 87.83 feet Lowest Elevation Point 44.58 feet Elevation Difference 43.25 feet Horizontal Difference 147.66 feet 87.83 - 44.58 = 43.25 / 147.66 = 29.29%

Lot Coverage		2.27	1005
House, including eaves		,	I.0 SF
Driveway		1,300).0 SF
Guest Parking		583	3.0 SF
Proposed Lot Coverage	5,257.0	SF	31.1%

Hardscape		
Entry Walkway	112.0 SF	
Pantry Walkway	187.0 SF	
Garage Walkway	58.0 SF	
Deck	144.0 SF	
Flagstone Patio	200.0 SF	
Retaining Wall	9.0 SF	
Proposed Hardscape	710.0 SF	4.2%
Allowable Hardscape	1,519.0 SF	9.0%

	Midpoint Elevation	Segm	ent Length	Elev x Length
A	63.0	24.0	feet	1512.0
3	62.5	86.0	feet	5375.0
С	64.0	24.0	feet	1536.0
D	70.5	53.0	feet	3736.5
Ε	71.0	7.5	feet	532.5
F	71.0	8.0	feet	568.0
G	71.0	7.5	feet	532.5
H	64.0	25.3	feet	1619.2
Total	537.0	235.3	feet	15411.7




2021-10-25

DATE: OCTOBER 25, 2021

SHEET TITLE:

ZONING DIAGRAMS

SHEET:

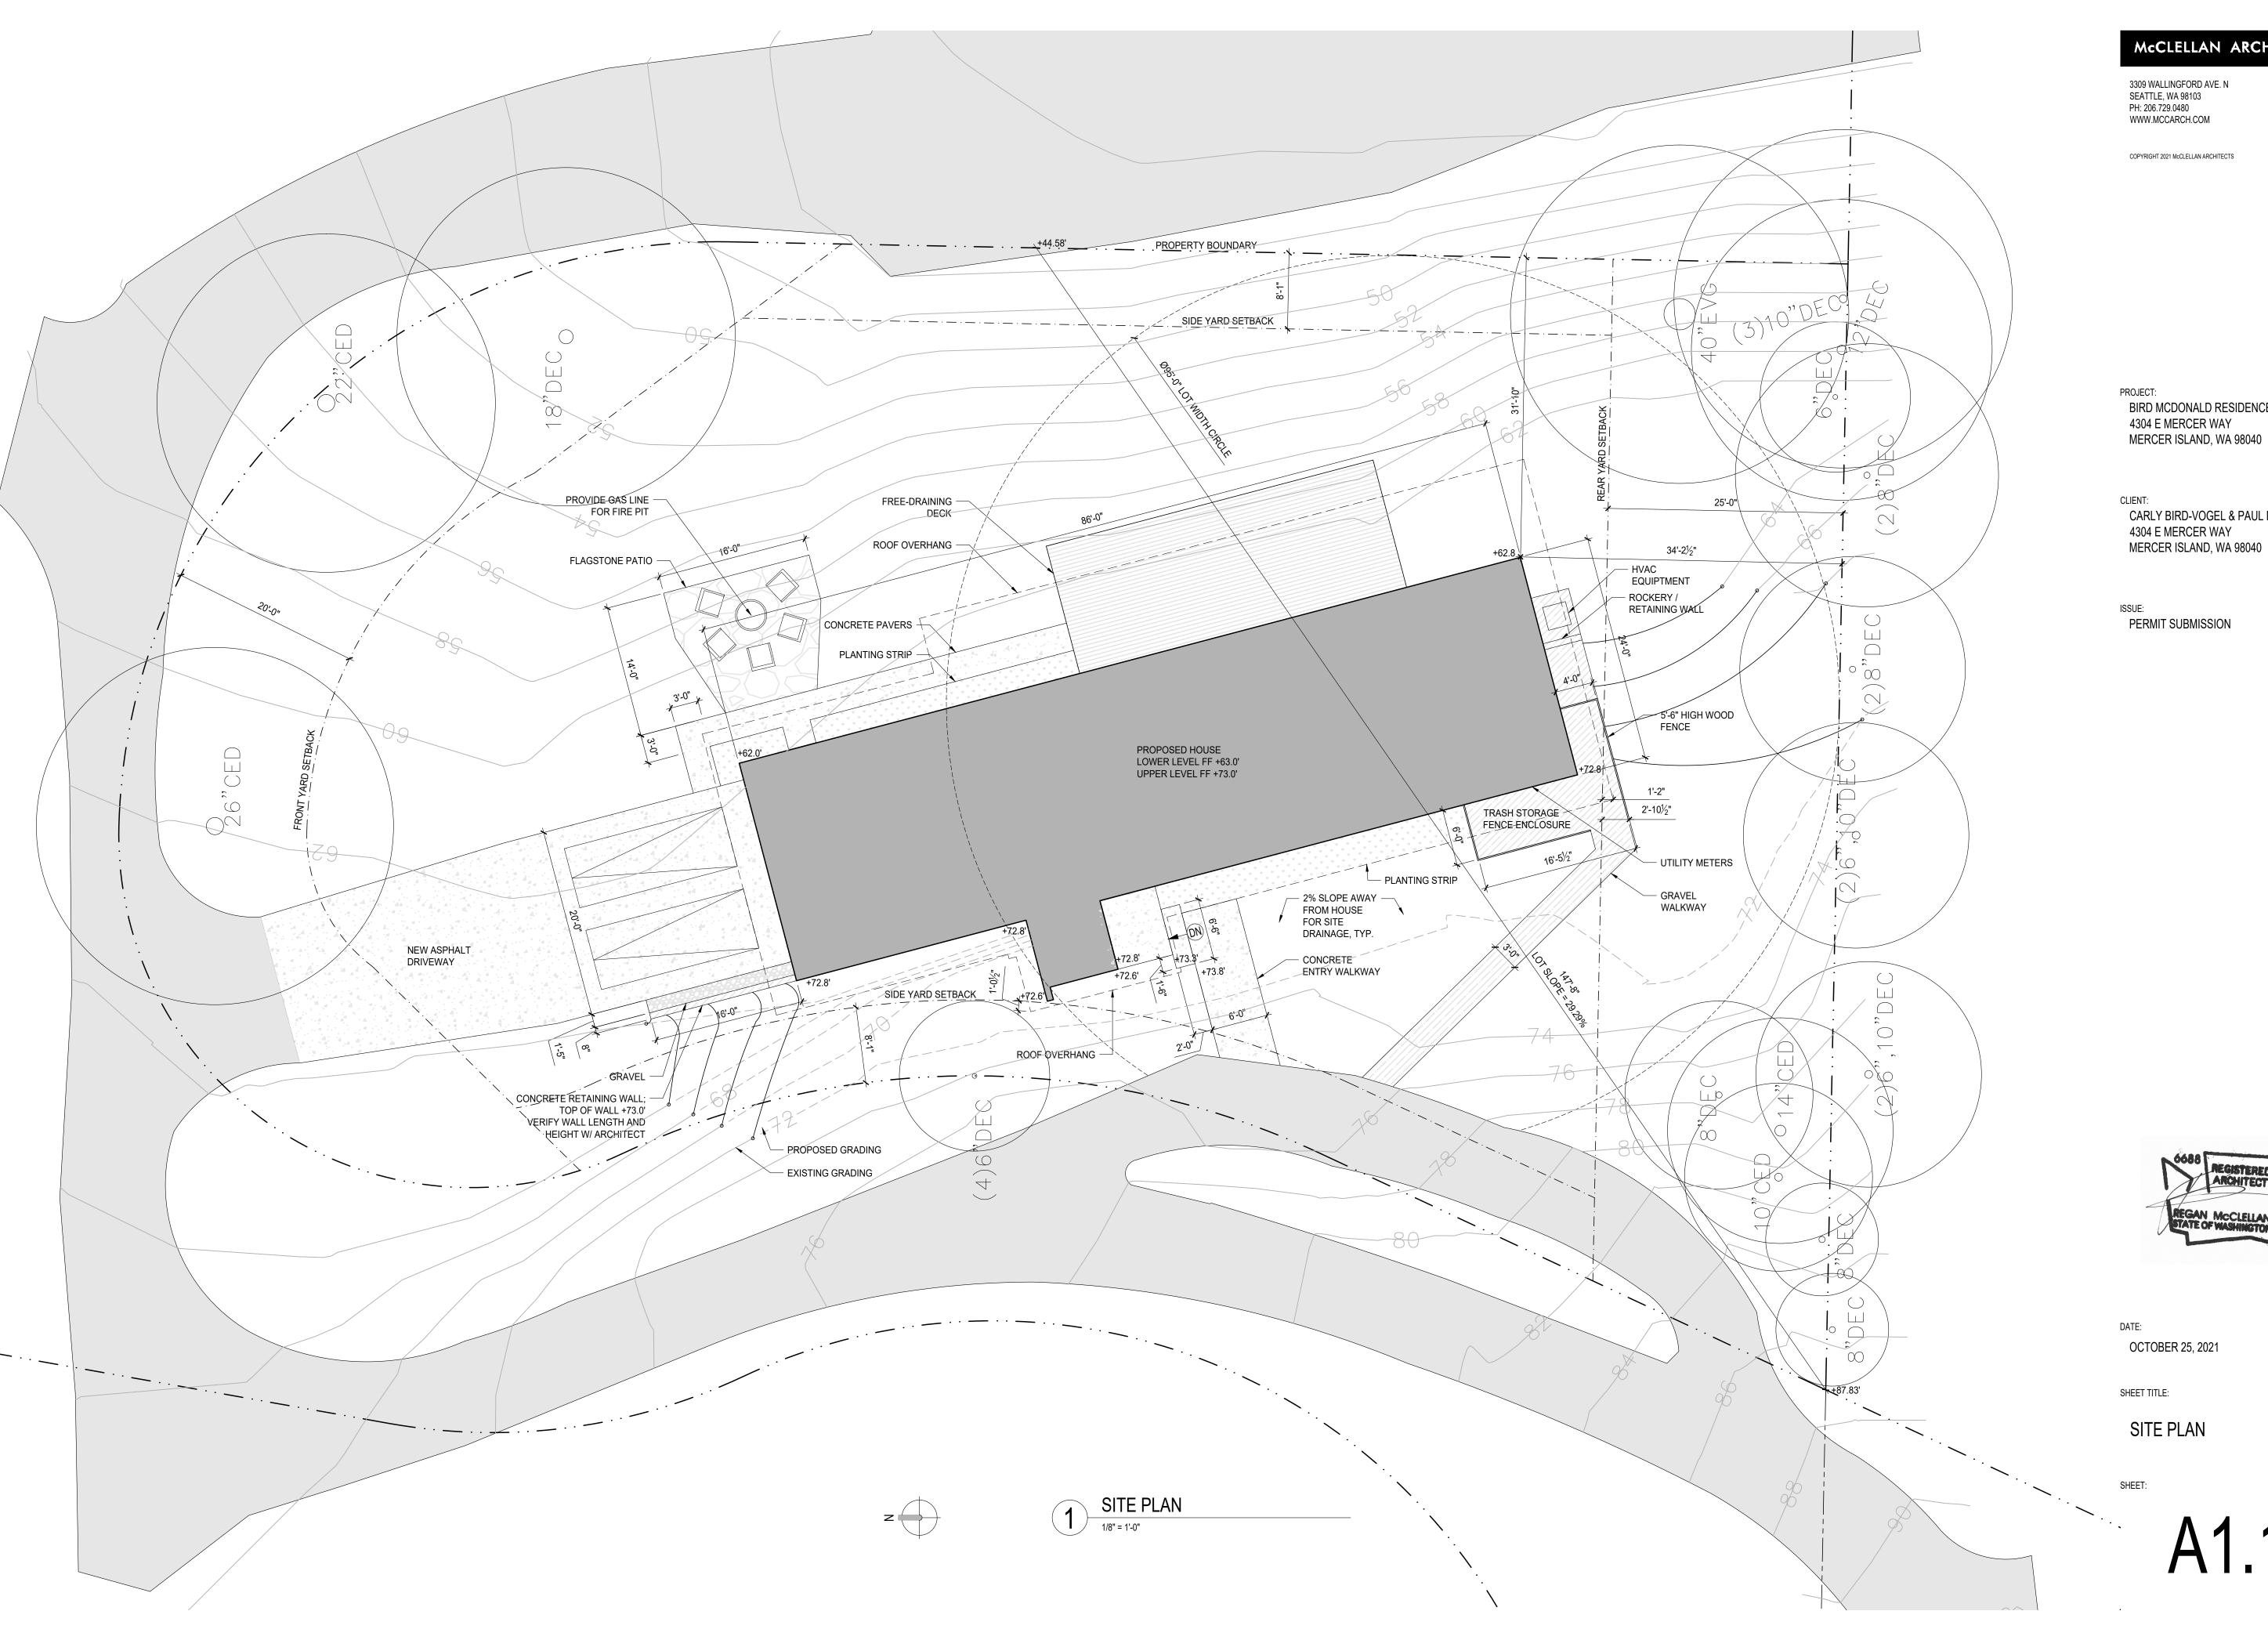


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BIRD MCDONALD RESIDENCE 4304 E MERCER WAY

CARLY BIRD-VOGEL & PAUL MCDONALD 4304 E MERCER WAY MERCER ISLAND, WA 98040

PERMIT SUBMISSION 2021-10-25

OCTOBER 25, 2021

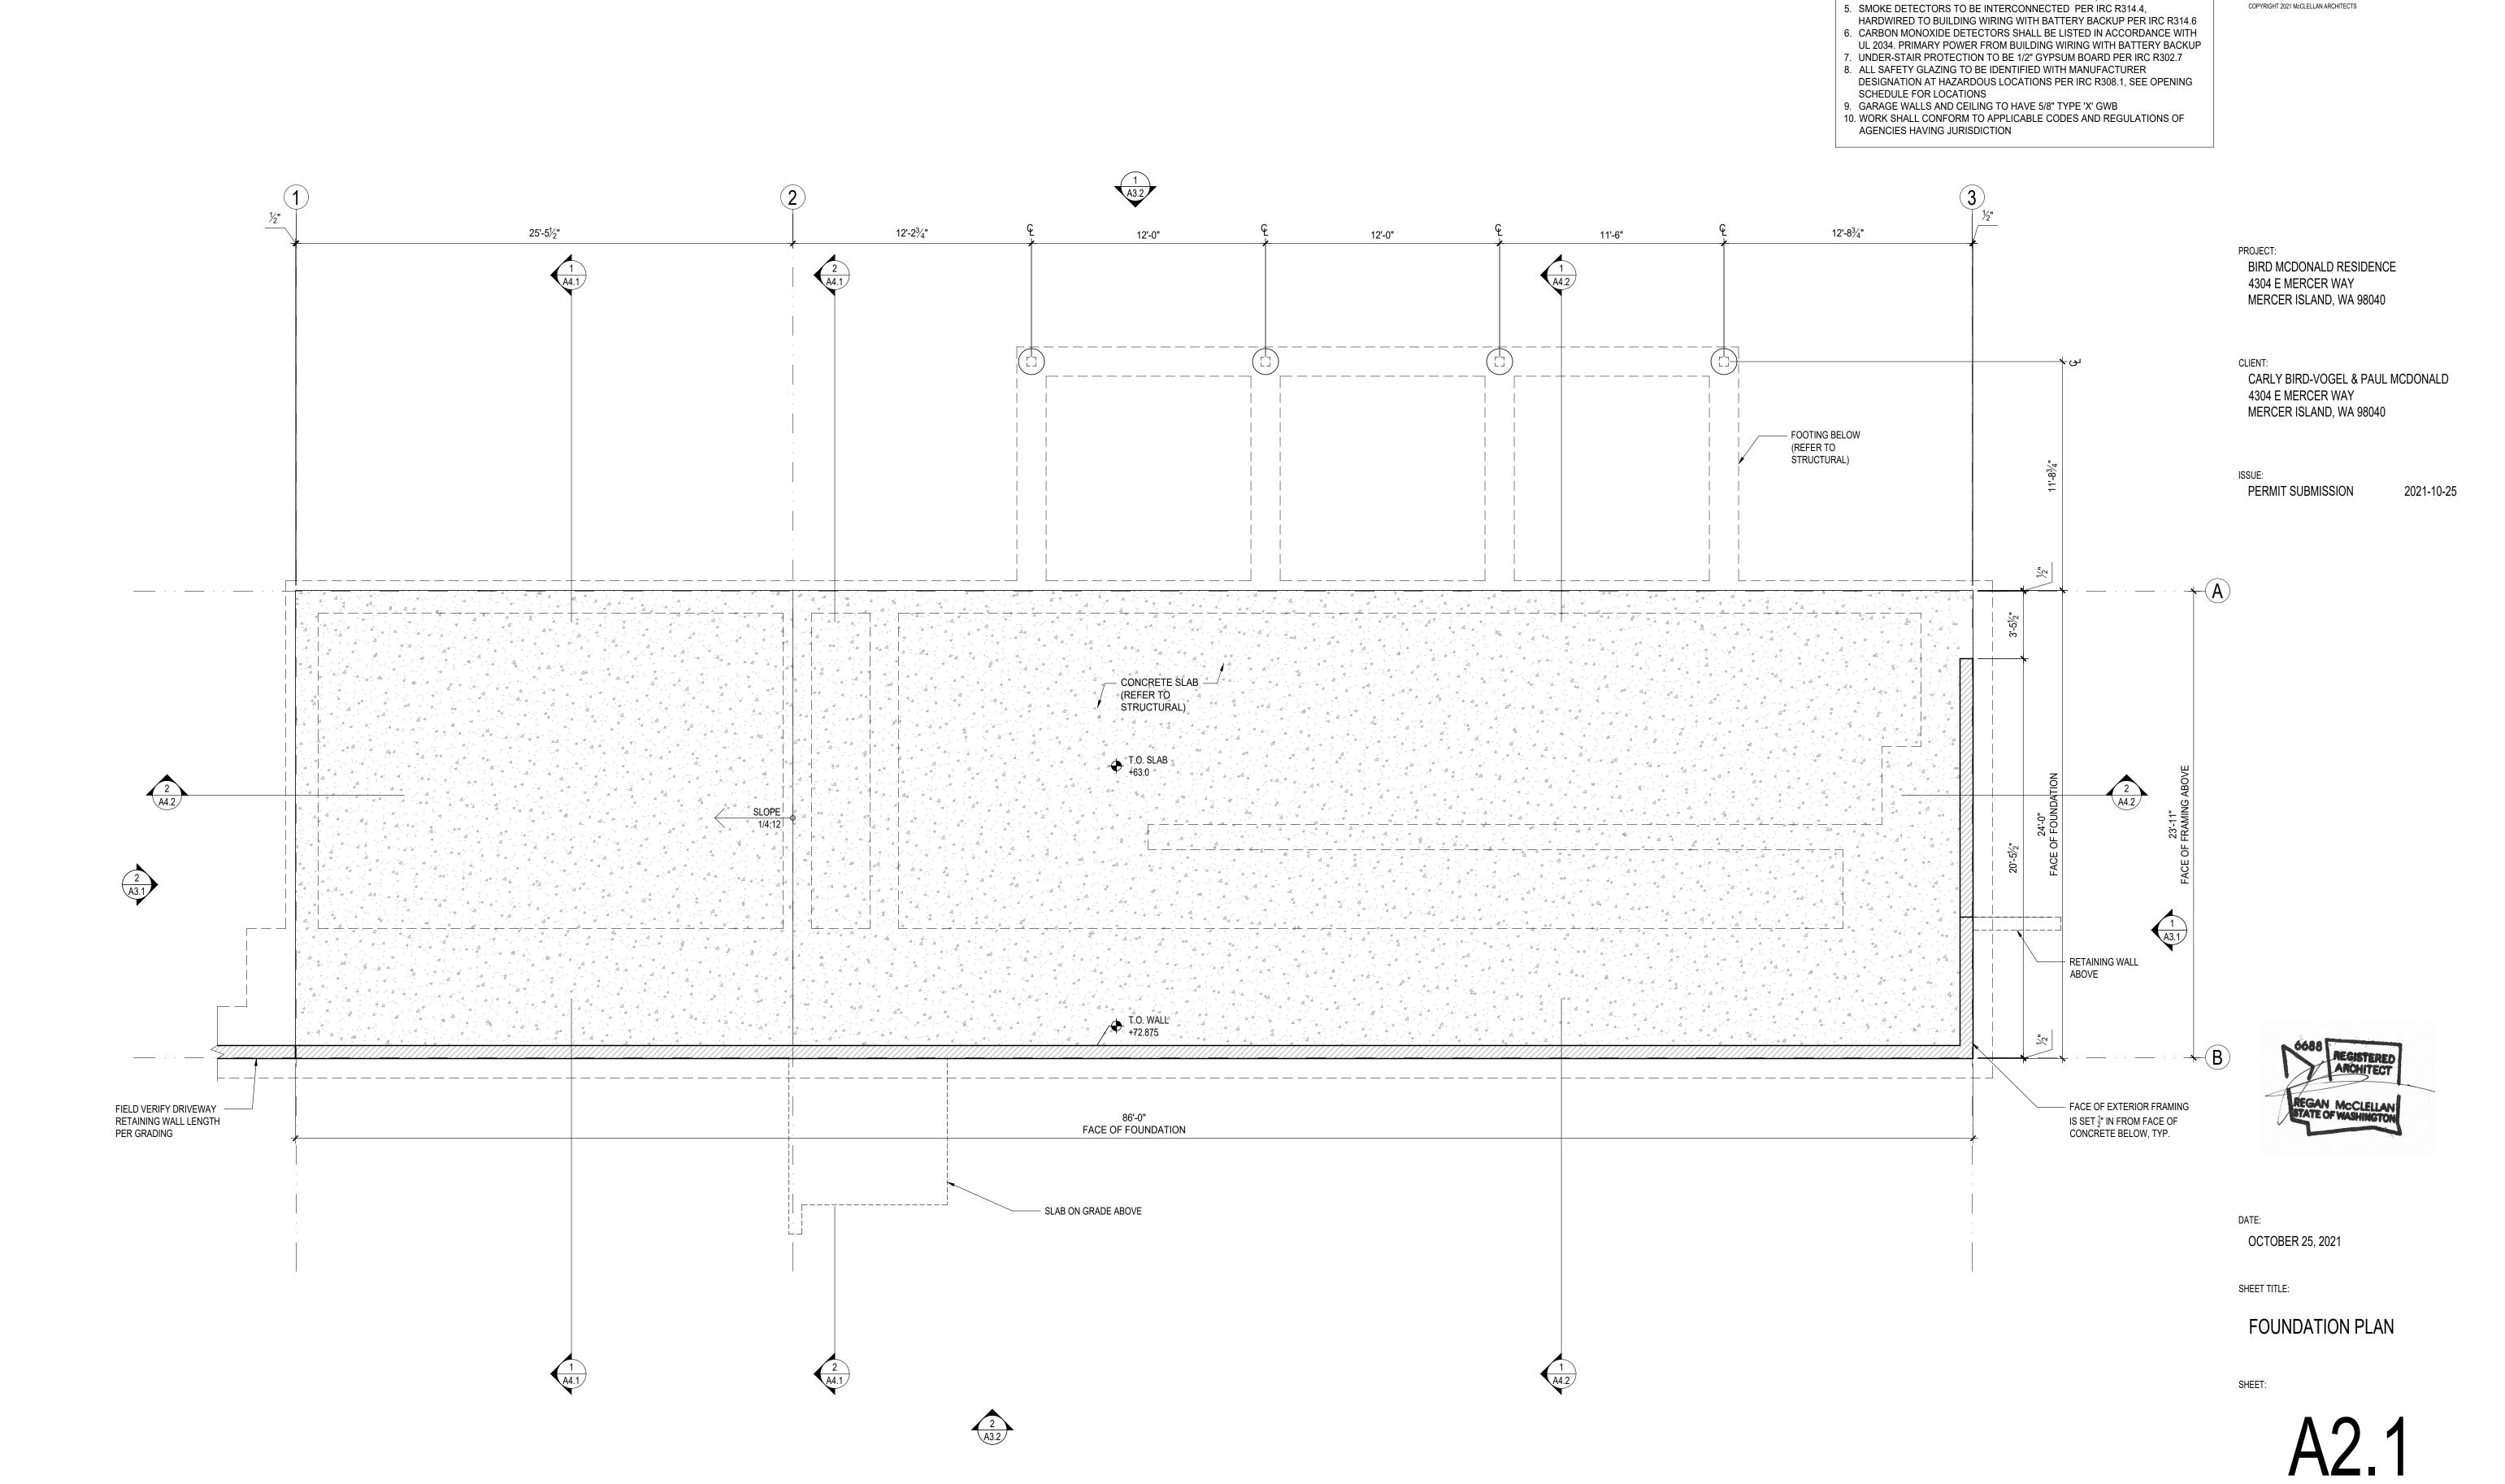

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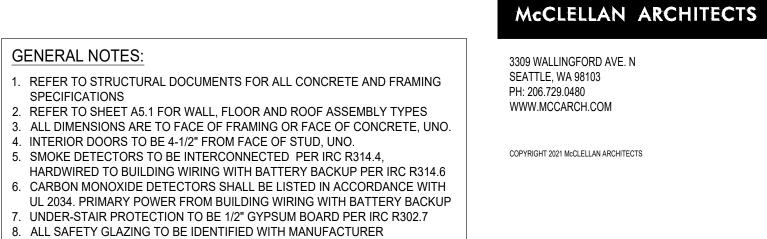
GENERAL NOTES:

SPECIFICATIONS

1. REFER TO STRUCTURAL DOCUMENTS FOR ALL CONCRETE AND FRAMING

2. REFER TO SHEET A5.1 FOR WALL, FLOOR AND ROOF ASSEMBLY TYPES
3. ALL DIMENSIONS ARE TO FACE OF FRAMING OR FACE OF CONCRETE, UNO.

4. INTERIOR DOORS TO BE 4-1/2" FROM FACE OF STUD, UNO.



DESIGNATION AT HAZARDOUS LOCATIONS PER IRC R308.1, SEE OPENING

10. WORK SHALL CONFORM TO APPLICABLE CODES AND REGULATIONS OF

9. GARAGE WALLS AND CEILING TO HAVE 5/8" TYPE 'X' GWB

GENERAL NOTES:

SPECIFICATIONS

SCHEDULE FOR LOCATIONS


AGENCIES HAVING JURISDICTION

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GENERAL NOTES: 1. REFER TO STRUCTURAL DOCUMENTS FOR ALL CONCRETE AND FRAMING SPECIFICATIONS 2. REFER TO SHEET A5.1 FOR WALL, FLOOR AND ROOF ASSEMBLY TYPES
3. ALL DIMENSIONS ARE TO FACE OF FRAMING OR FACE OF CONCRETE, UNO. WWW.MCCARCH.COM


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4. INTERIOR DOORS TO BE 4-1/2" FROM FACE OF STUD, UNO. 5. SMOKE DETECTORS TO BE INTERCONNECTED PER IRC R314.4, HARDWIRED TO BUILDING WIRING WITH BATTERY BACKUP PER IRC R314.6 6. CARBON MONOXIDE DETECTORS SHALL BE LISTED IN ACCORDANCE WITH

UL 2034. PRIMARY POWER FROM BUILDING WIRING WITH BATTERY BACKUP 7. UNDER-STAIR PROTECTION TO BE 1/2" GYPSUM BOARD PER IRC R302.7 8. ALL SAFETY GLAZING TO BE IDENTIFIED WITH MANUFACTURER DESIGNATION AT HAZARDOUS LOCATIONS PER IRC R308.1, SEE OPENING

SCHEDULE FOR LOCATIONS 9. GARAGE WALLS AND CEILING TO HAVE 5/8" TYPE 'X' GWB 10. WORK SHALL CONFORM TO APPLICABLE CODES AND REGULATIONS OF

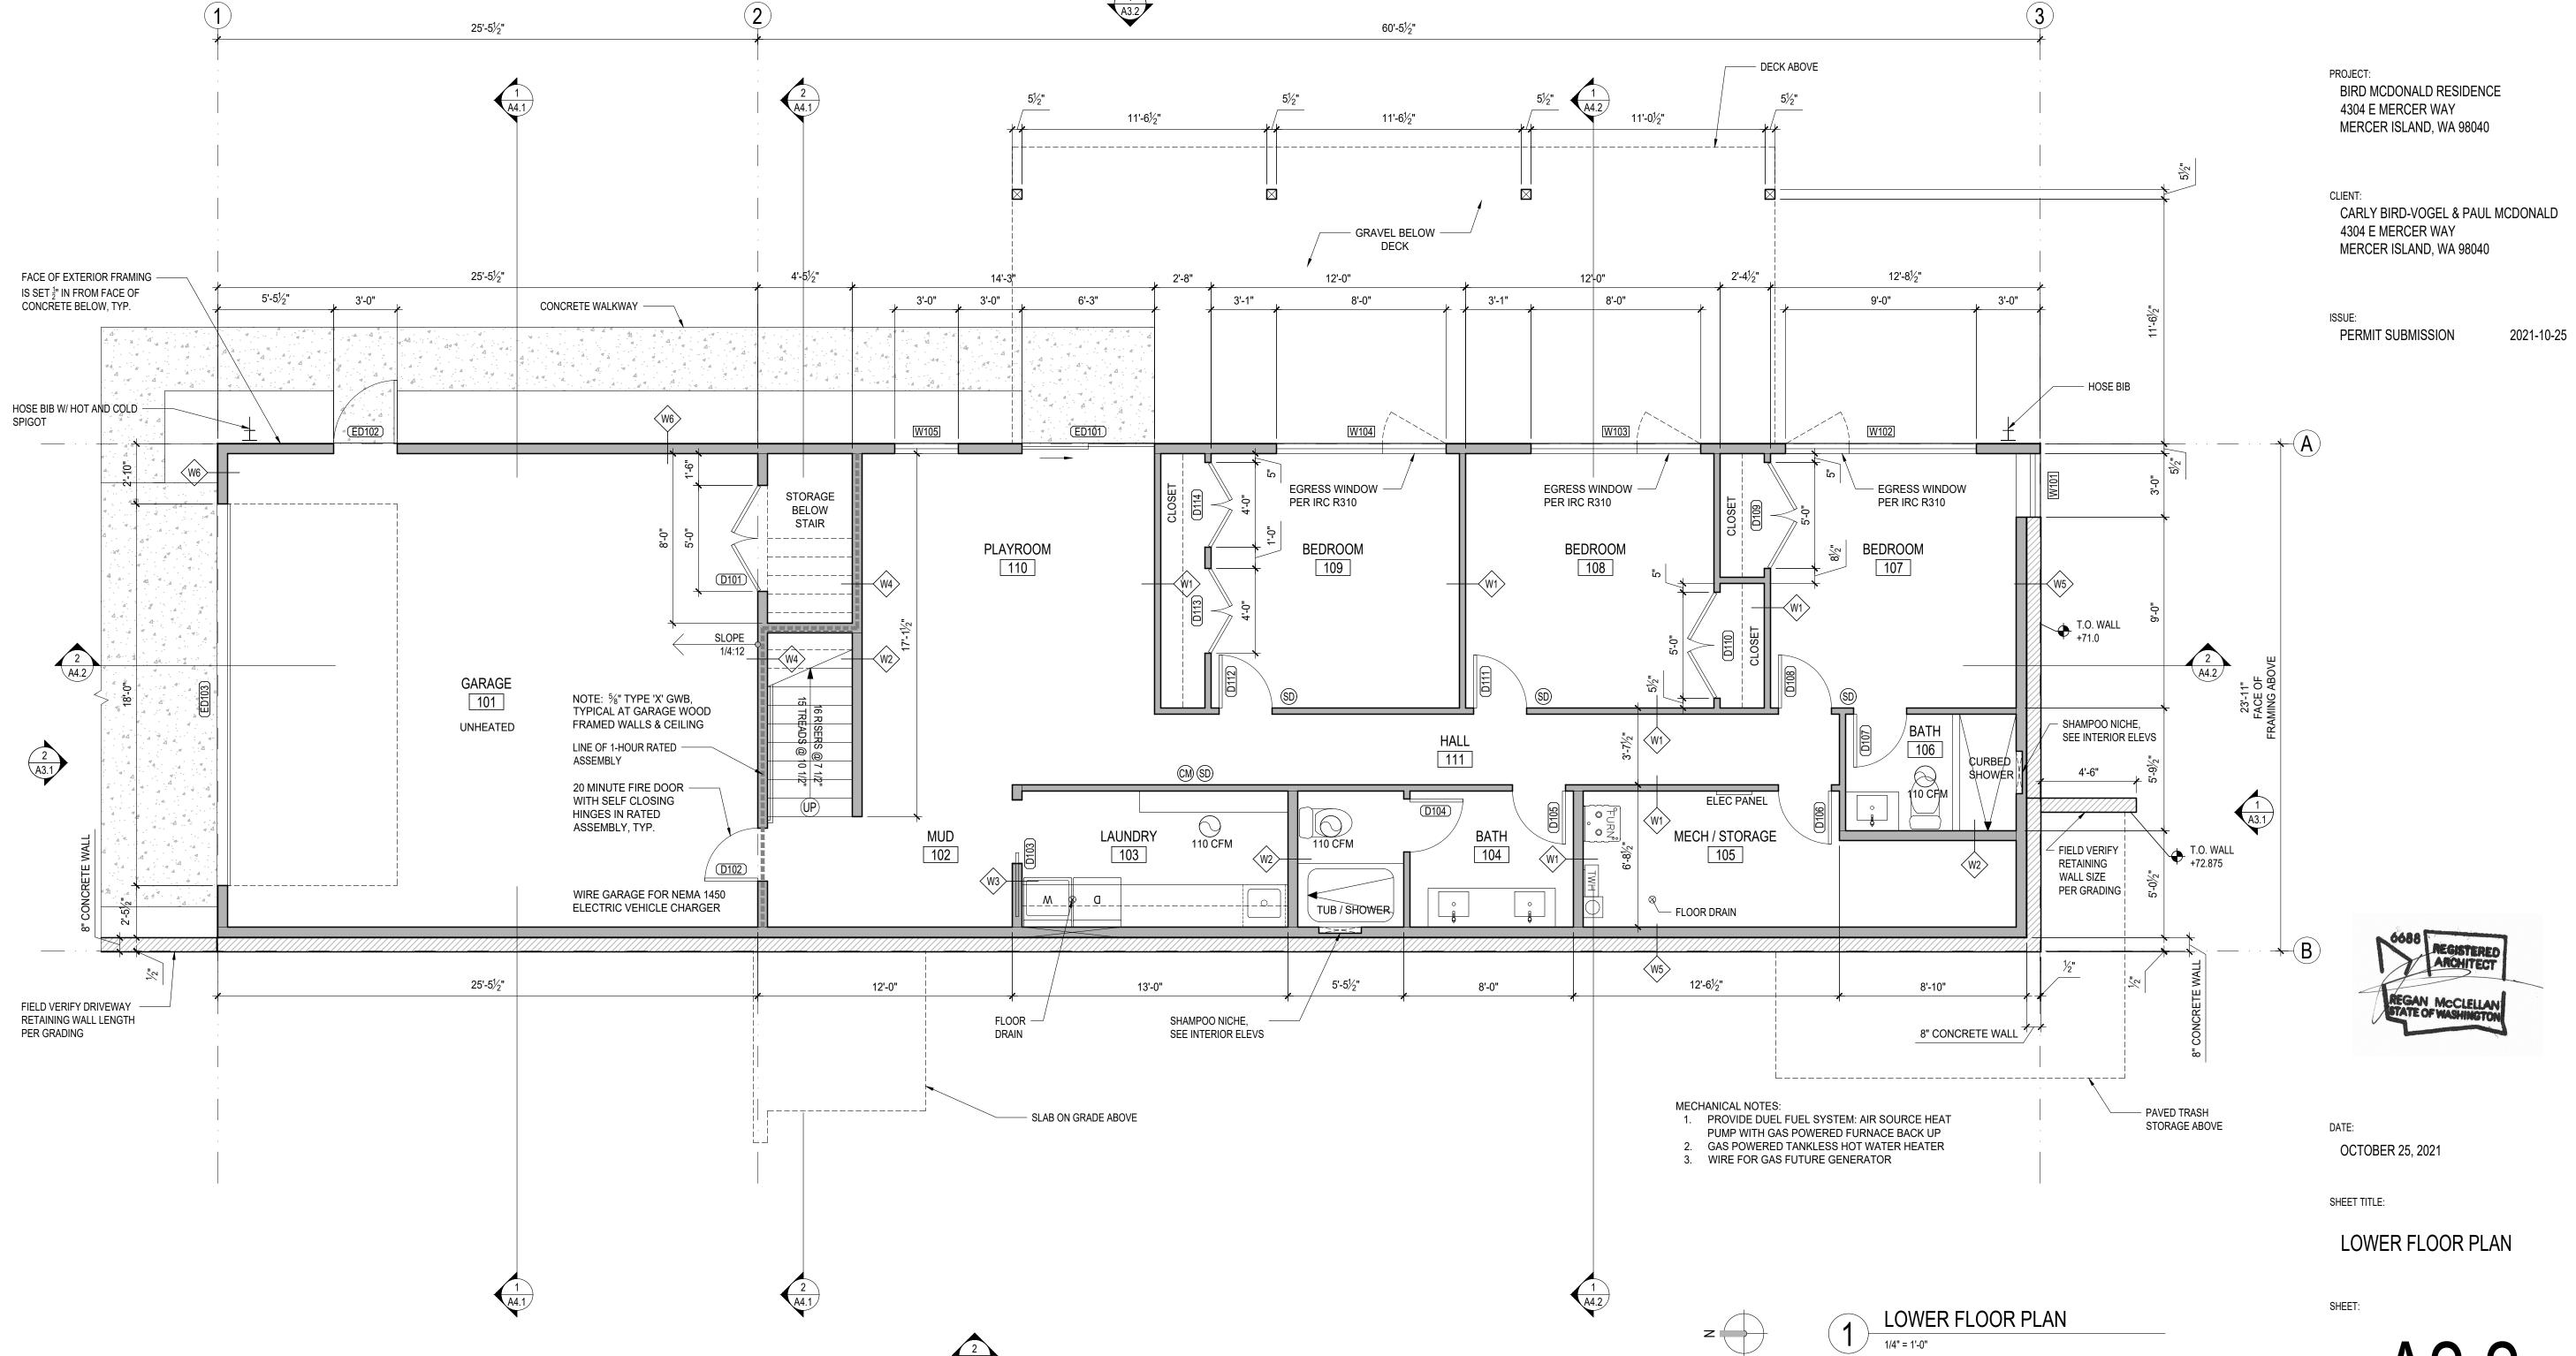AGENCIES HAVING JURISDICTION

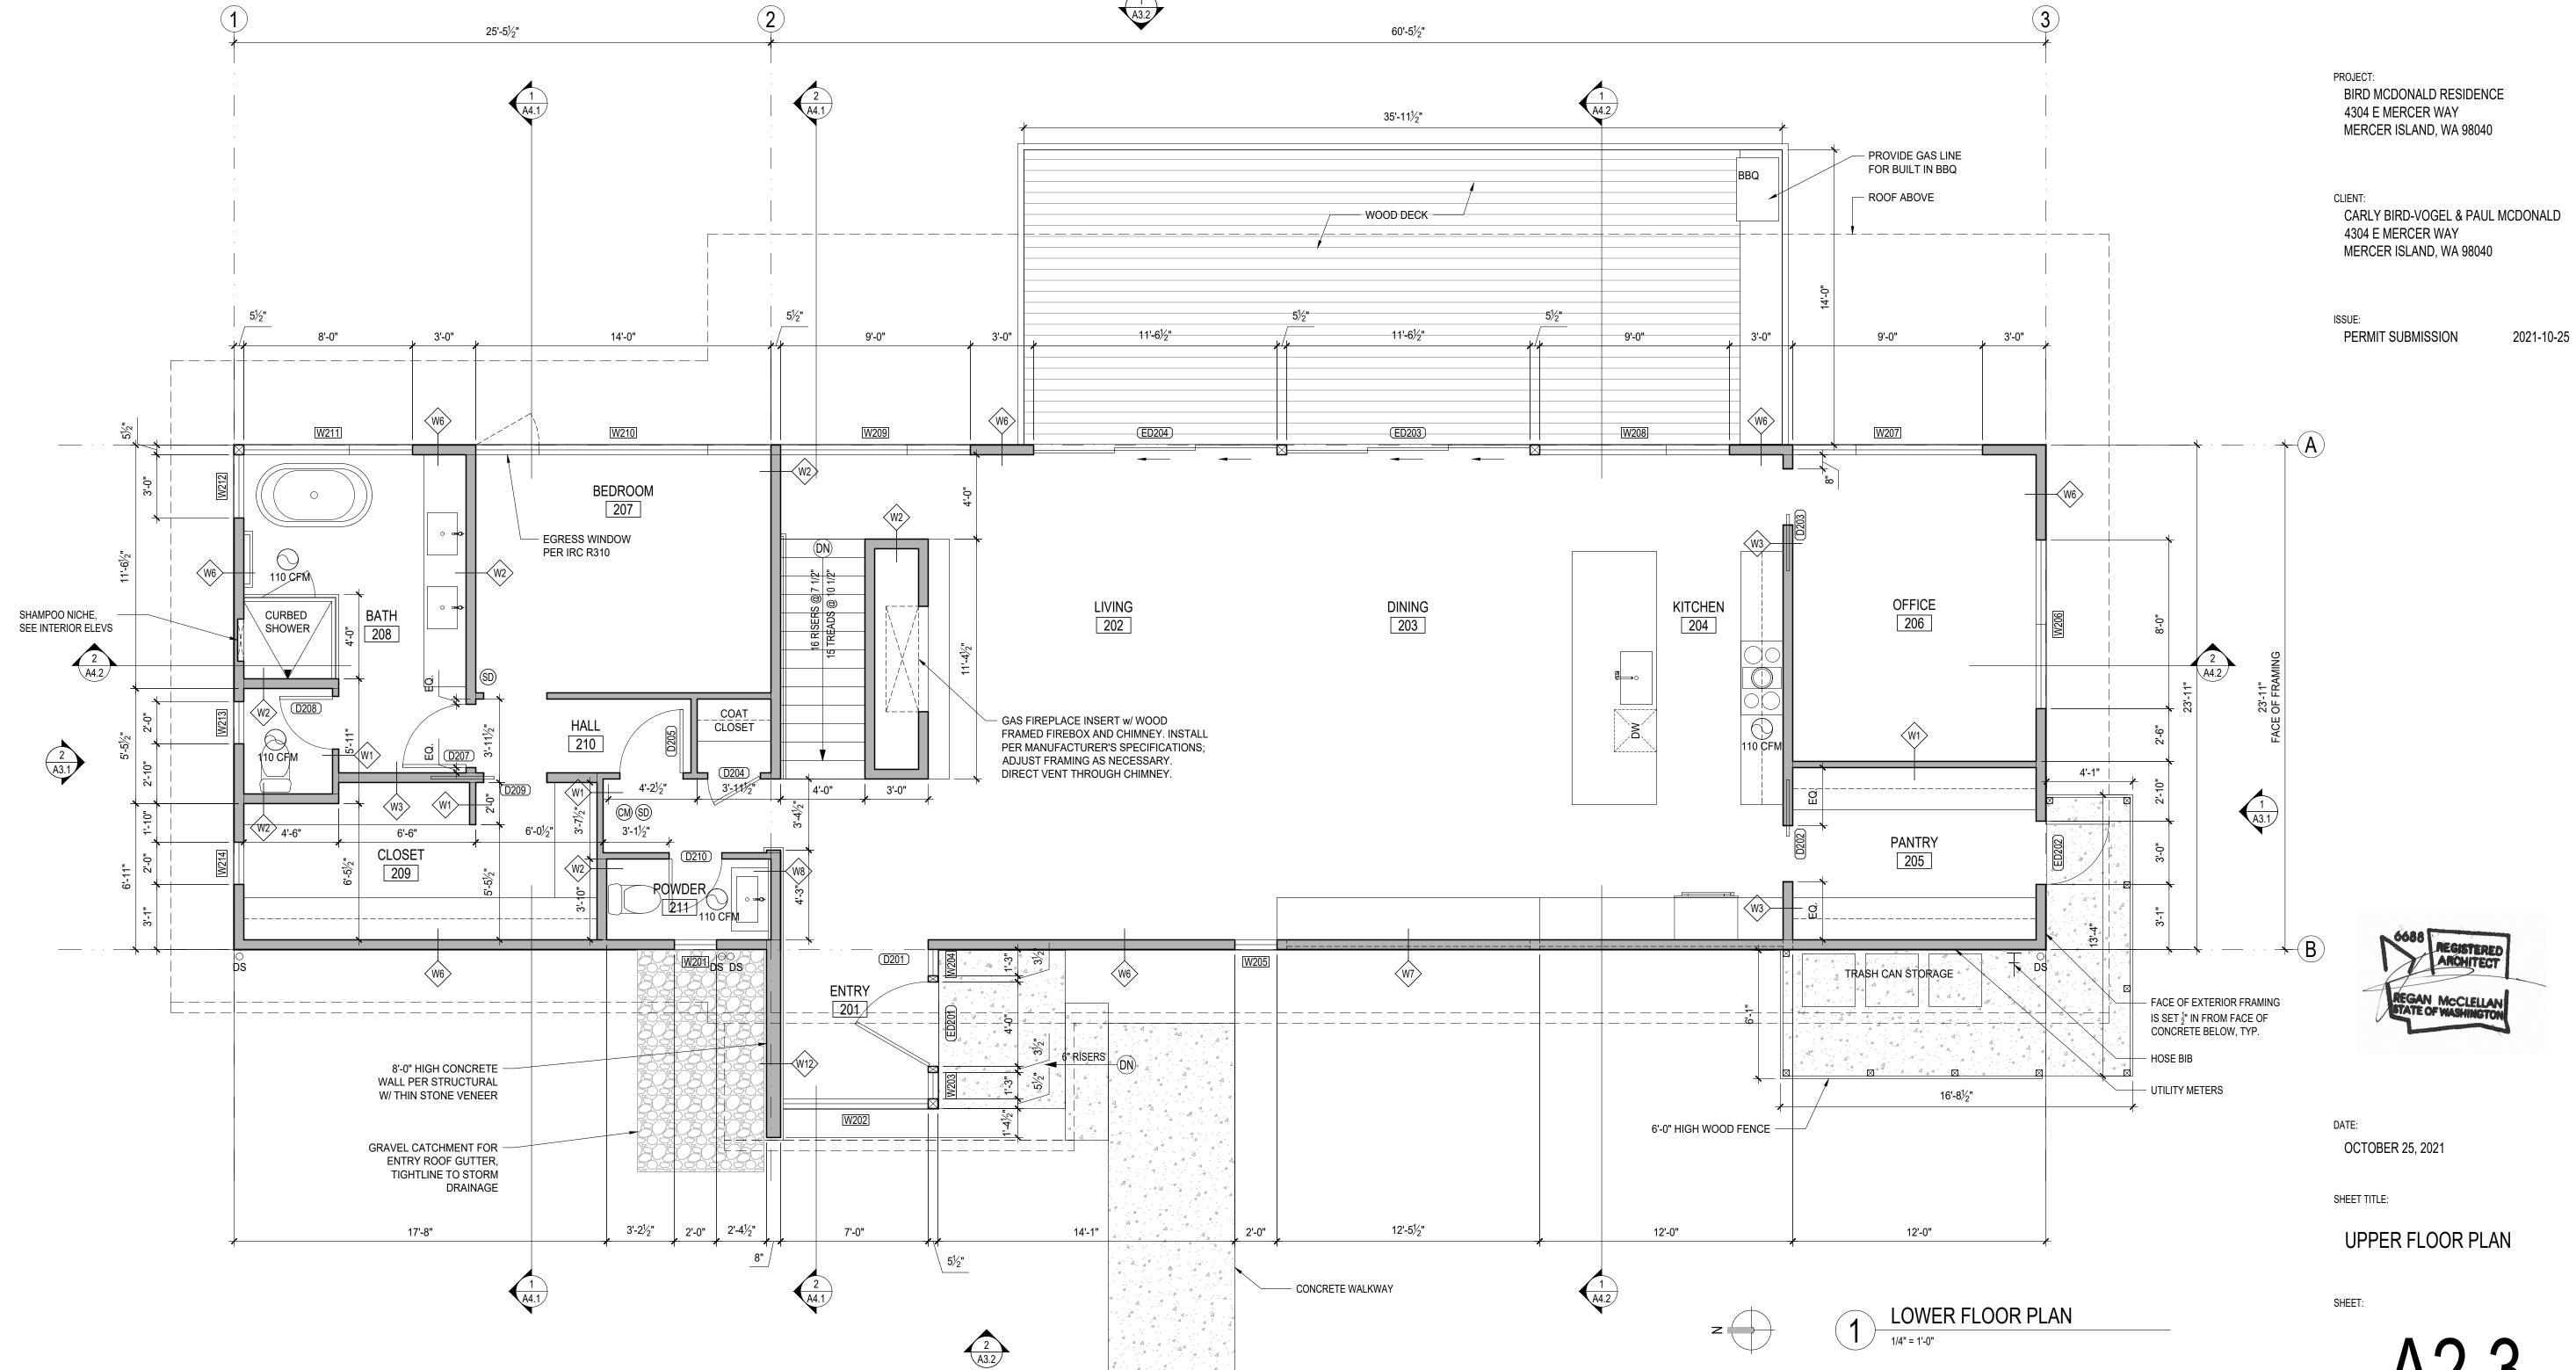

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PROJECT:

CLIENT:

BIRD MCDONALD RESIDENCE

MERCER ISLAND, WA 98040

CARLY BIRD-VOGEL & PAUL MCDONALD

4304 E MERCER WAY

4304 E MERCER WAY

PERMIT SUBMISSION

MERCER ISLAND, WA 98040

GENERAL NOTES:

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REFER TO SHEET A5.1 FOR WALL, FLOOR AND ROOF ASSEMBLY TYPES
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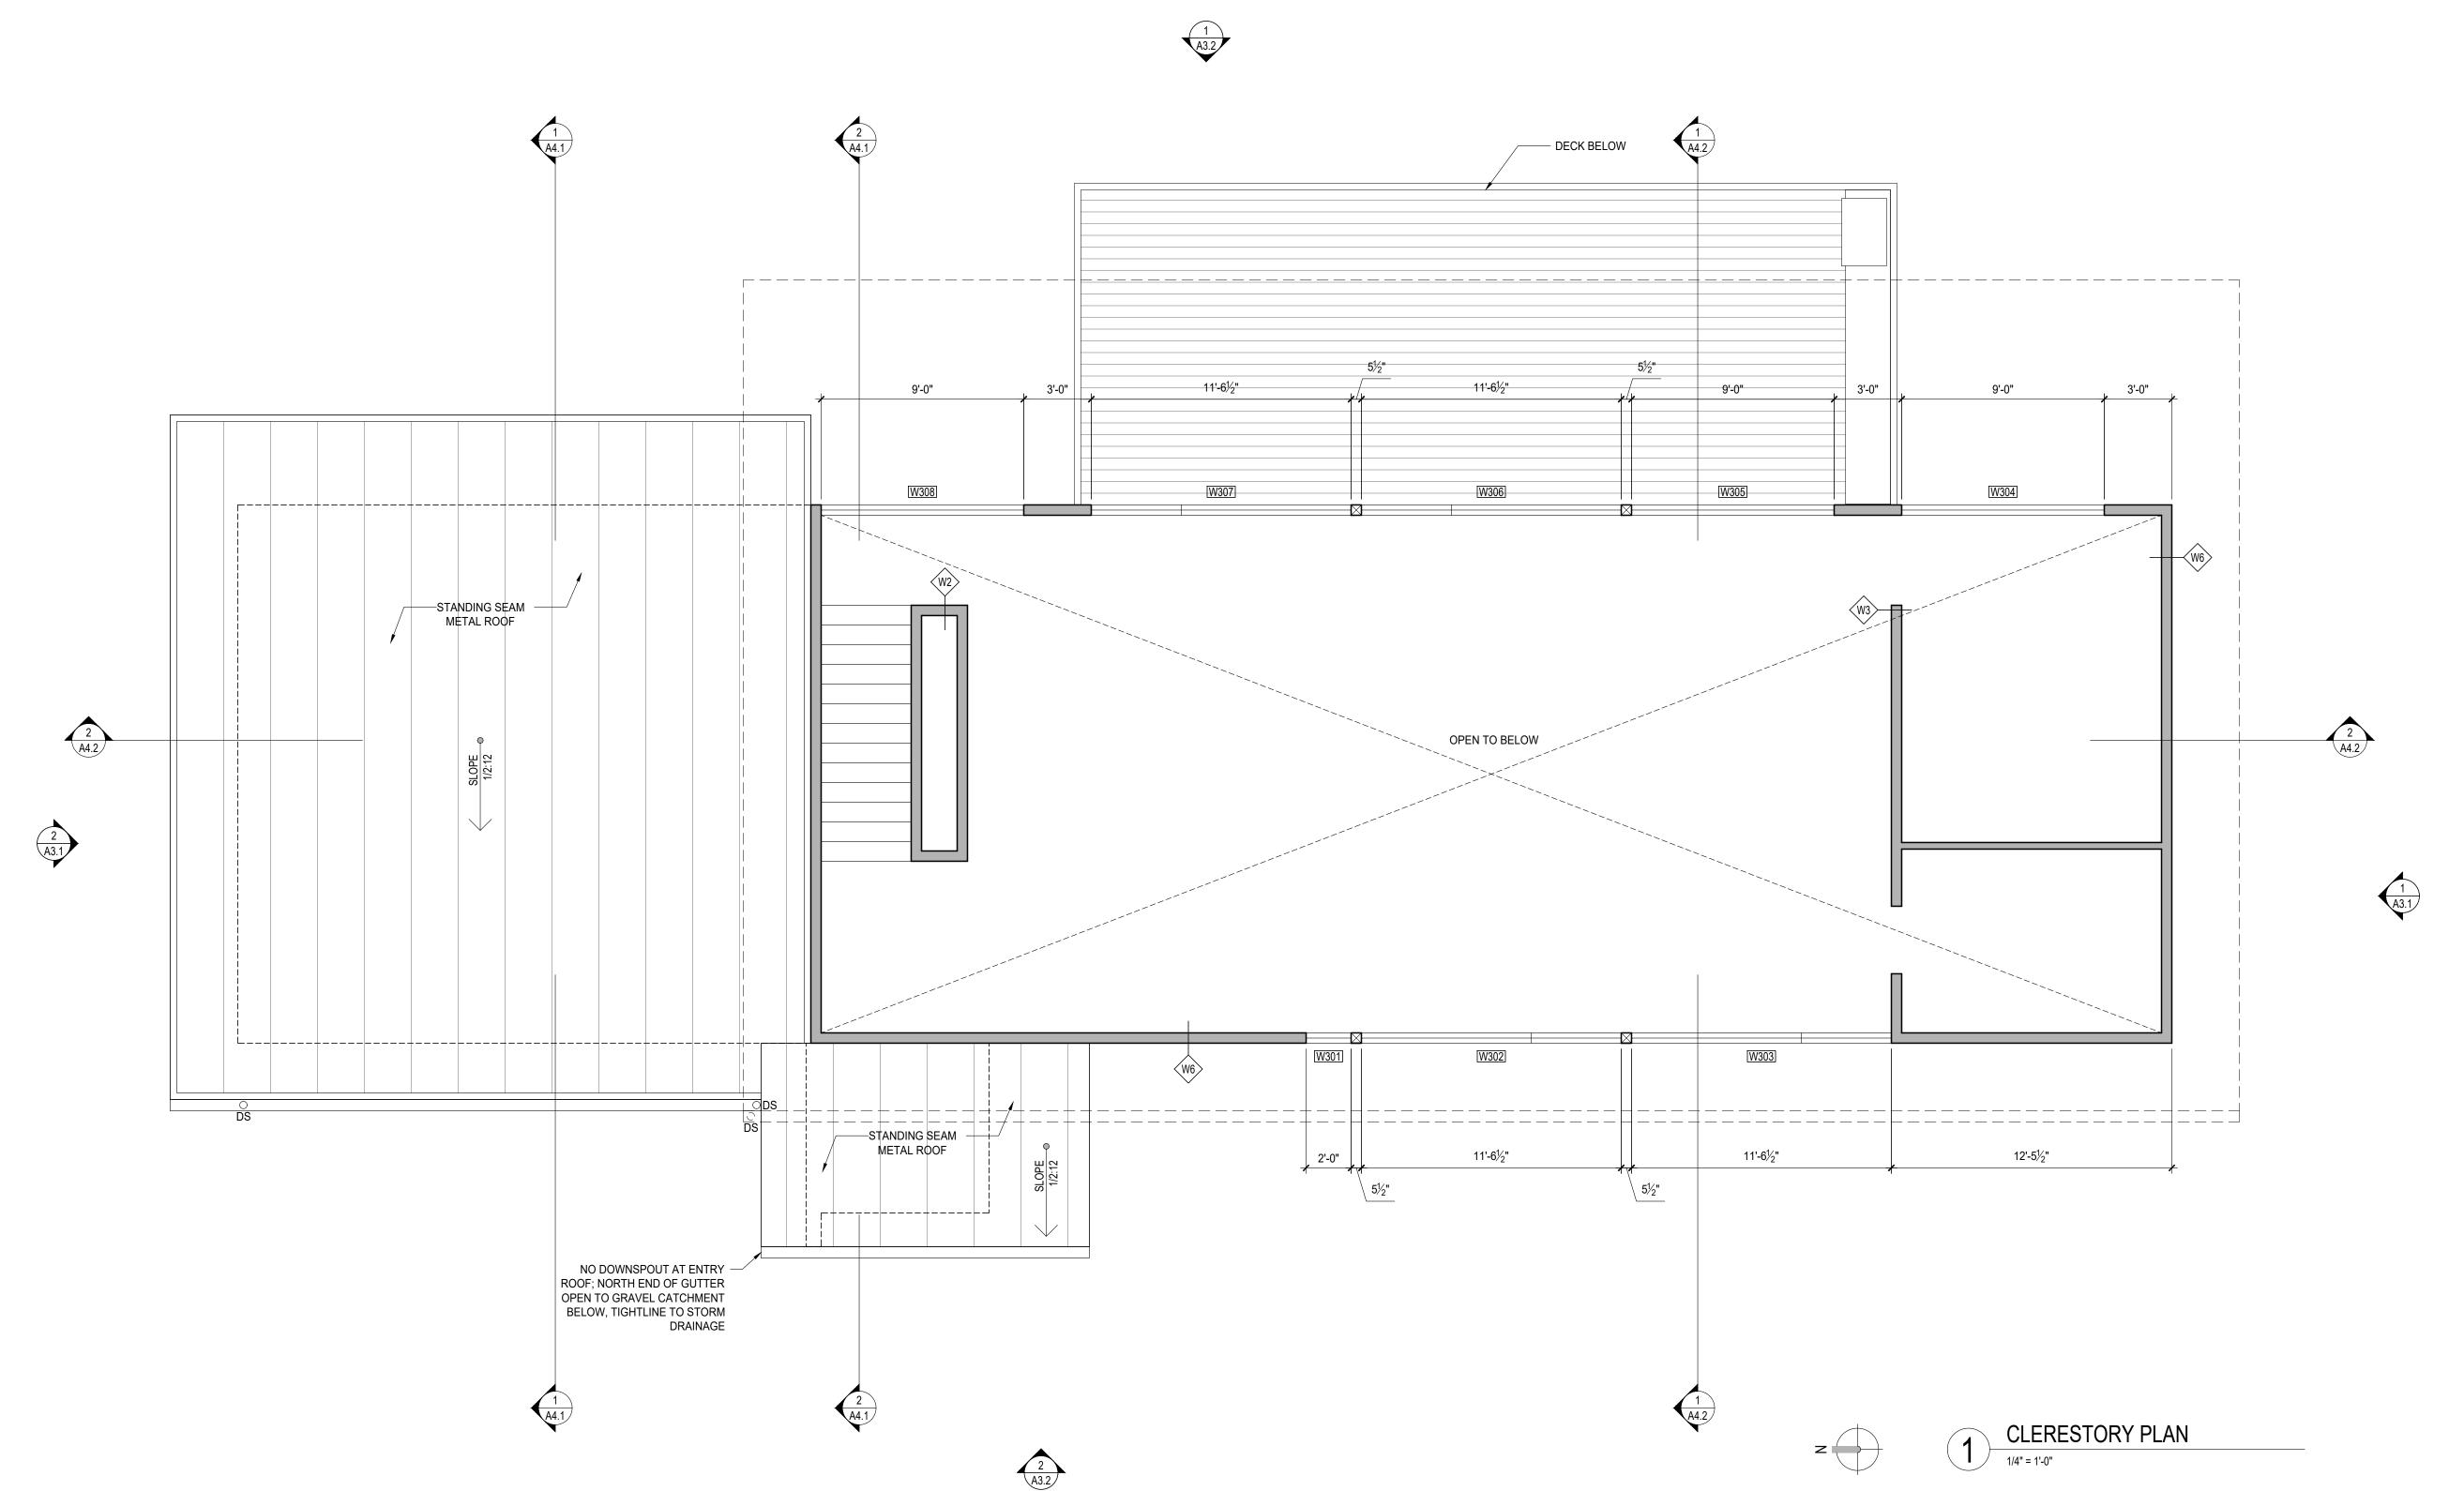
6. CARBON MONOXIDE DETECTORS SHALL BE LISTED IN ACCORDANCE WITH UL 2034. PRIMARY POWER FROM BUILDING WIRING WITH BATTERY BACKUP 7. UNDER-STAIR PROTECTION TO BE 1/2" GYPSUM BOARD PER IRC R302.7

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DESIGNATION AT HAZARDOUS LOCATIONS PER IRC R308.1, SEE OPENING
SCHEDULE FOR LOCATIONS

1. CARRAGE MALLS AND CELLING TO LAYE FOR TYPE IXI CIVIP.

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 GARAGE WALLS AND CEILING TO HAVE 5/8" TYPE 'X' GWB
 WORK SHALL CONFORM TO APPLICABLE CODES AND REGULATIONS OF AGENCIES HAVING JURISDICTION



ARCHITECT

DATE:

OCTOBER 25, 2021

SHEET TITLE:

CLERESTORY PLAN

SHEET:

A2.4

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2021-10-25

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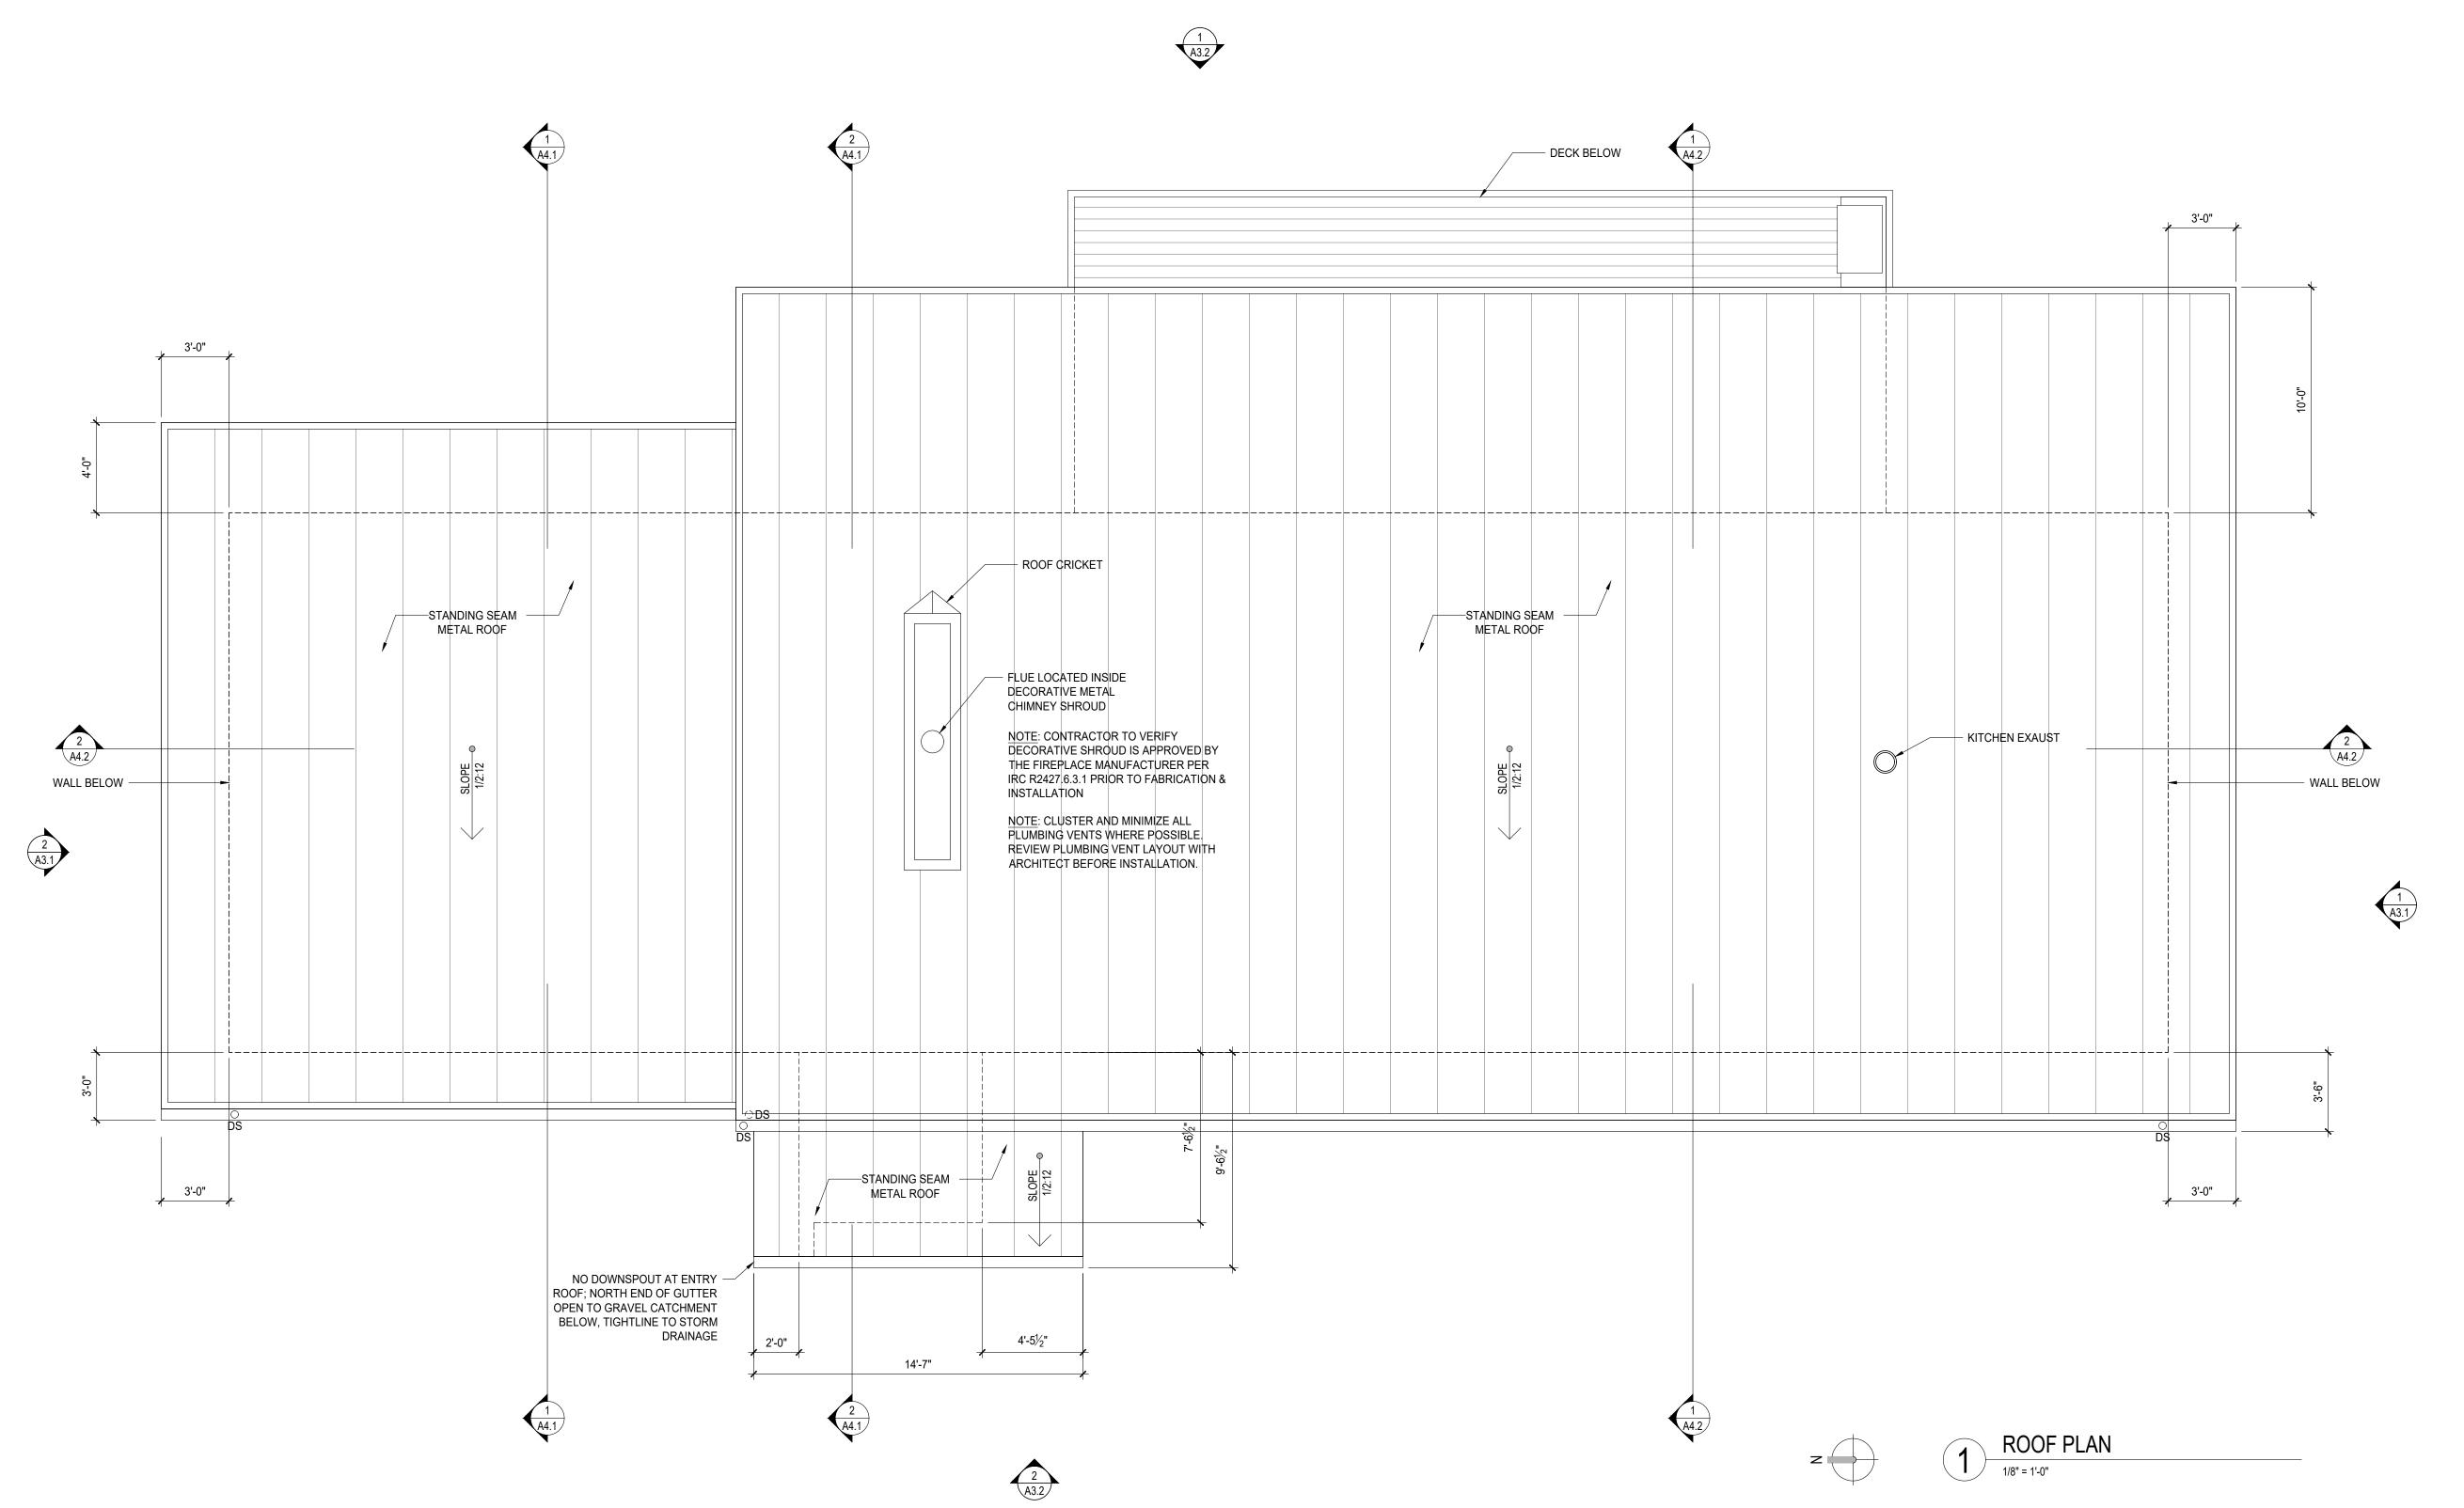
4304 E MERCER WAY

PERMIT SUBMISSION

MERCER ISLAND, WA 98040

GENERAL NOTES:

- 1. REFER TO STRUCTURAL DOCUMENTS FOR ALL CONCRETE AND FRAMING SPECIFICATIONS
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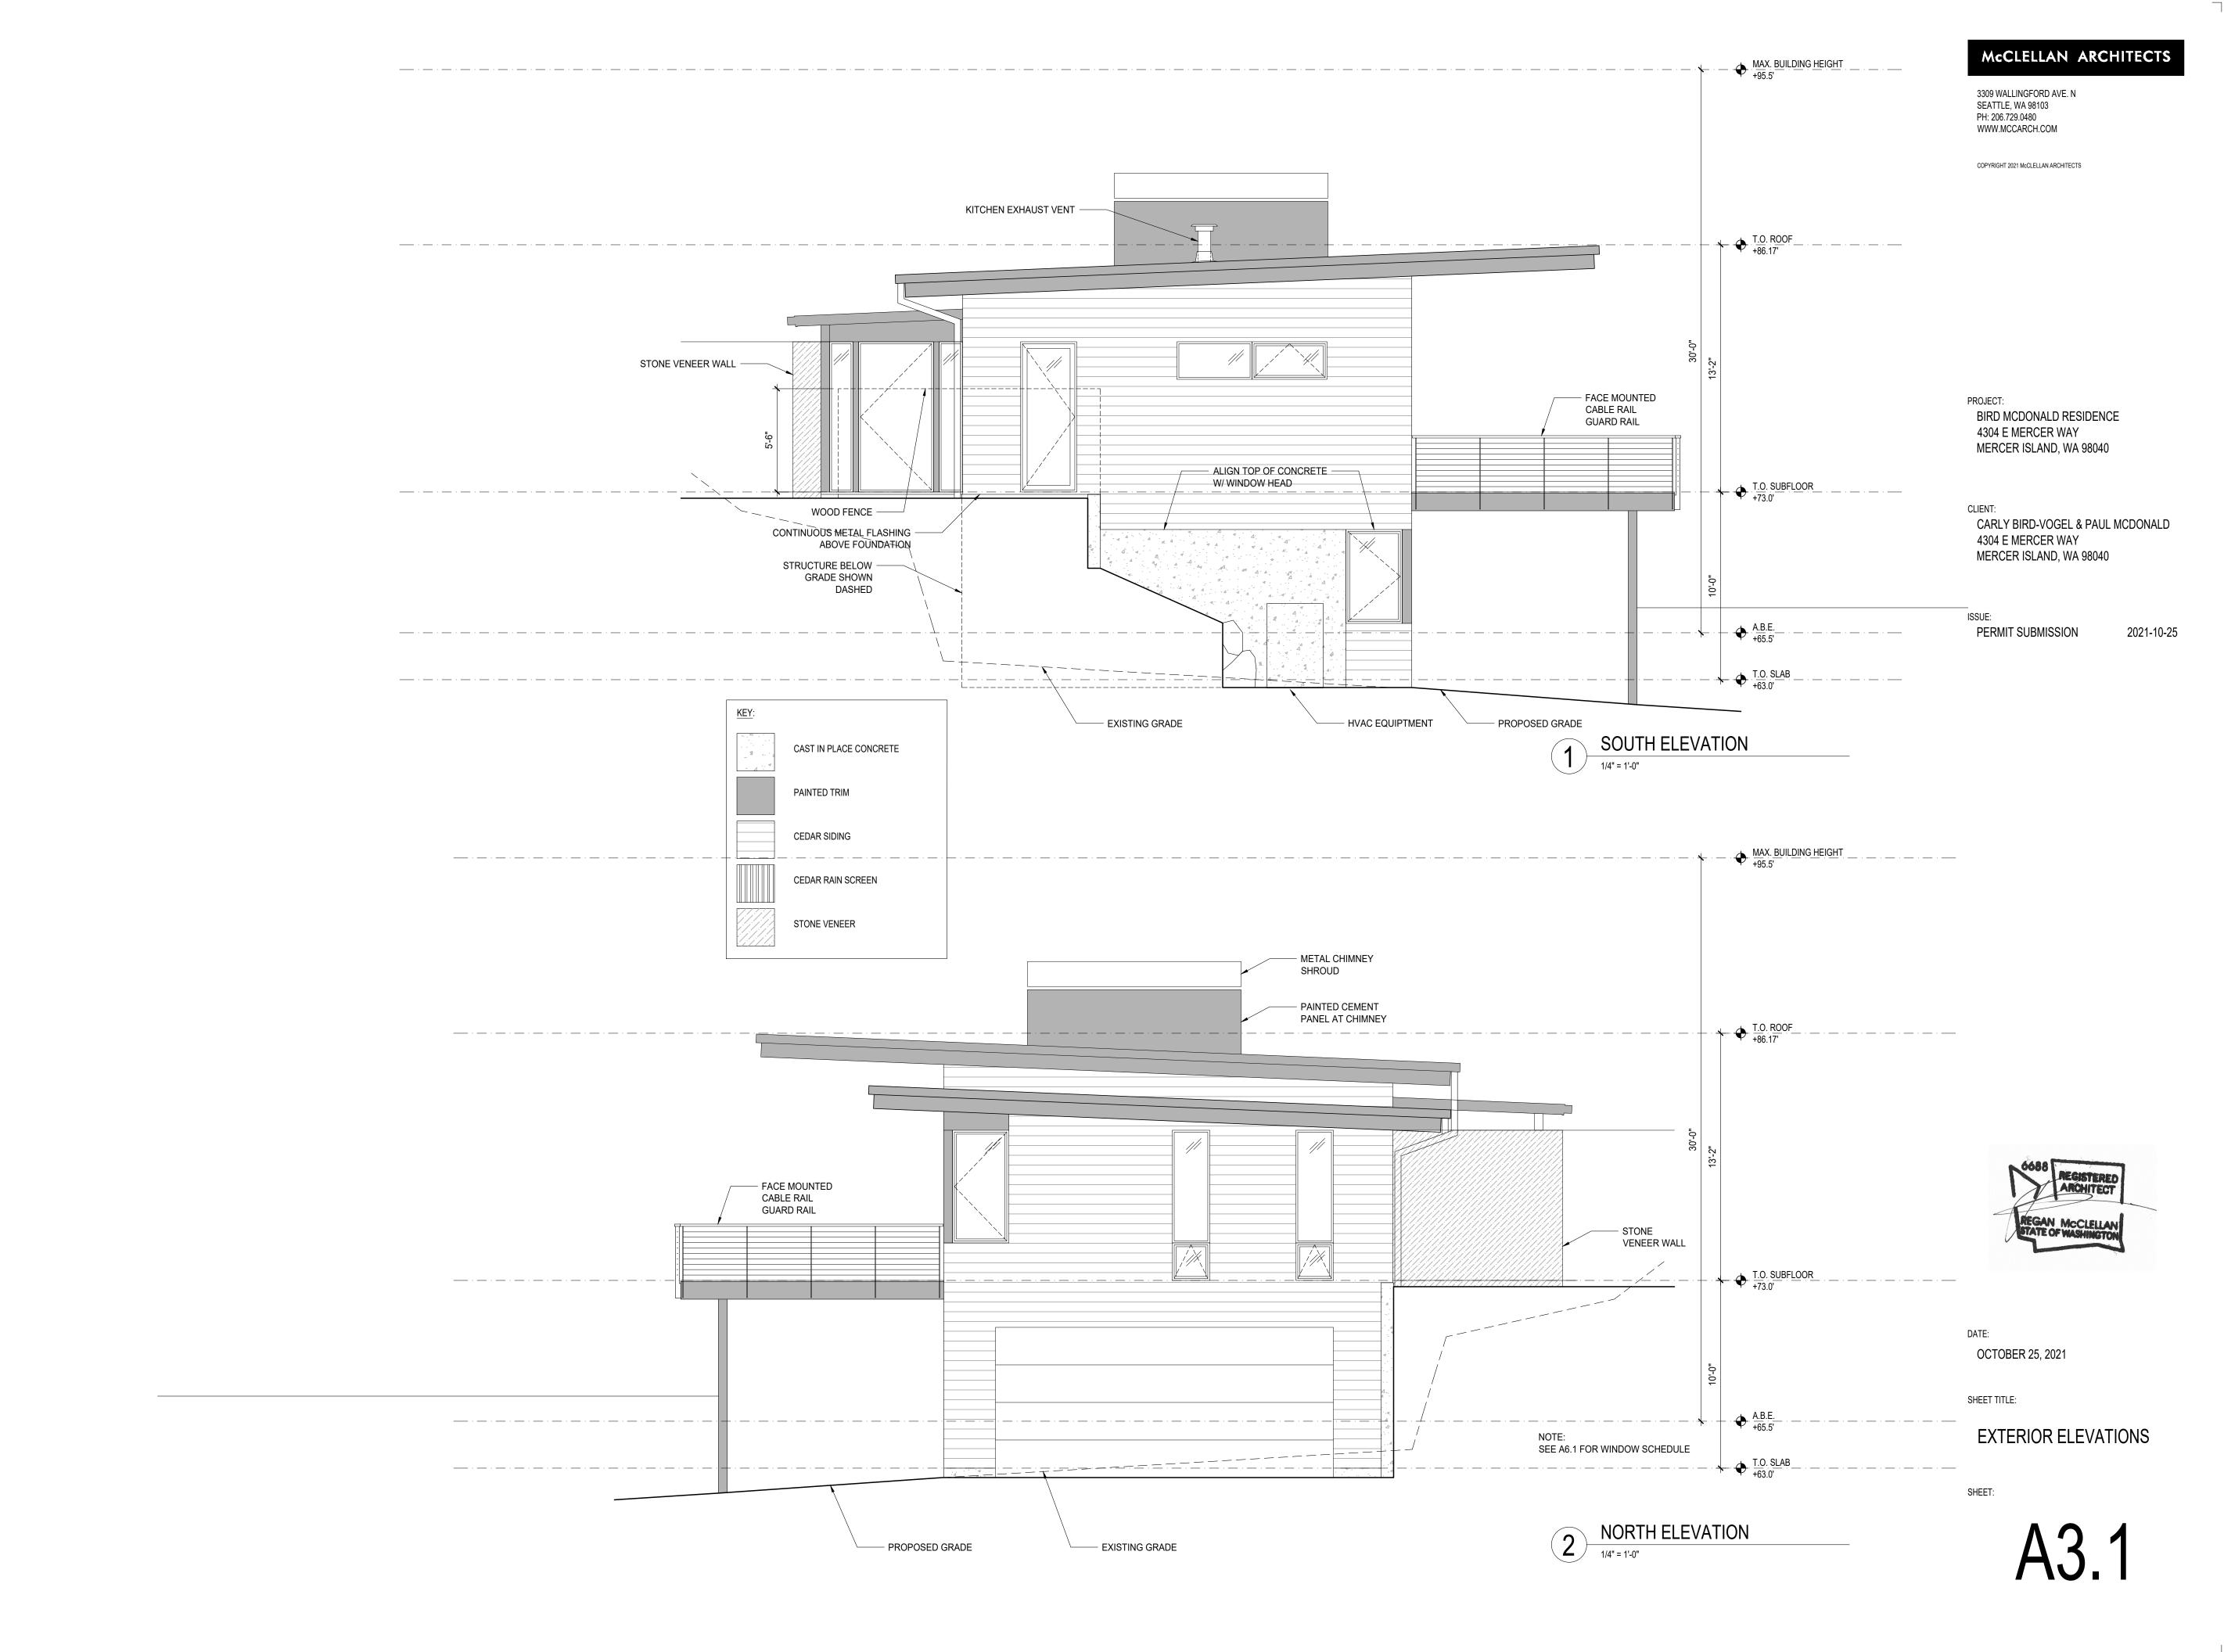
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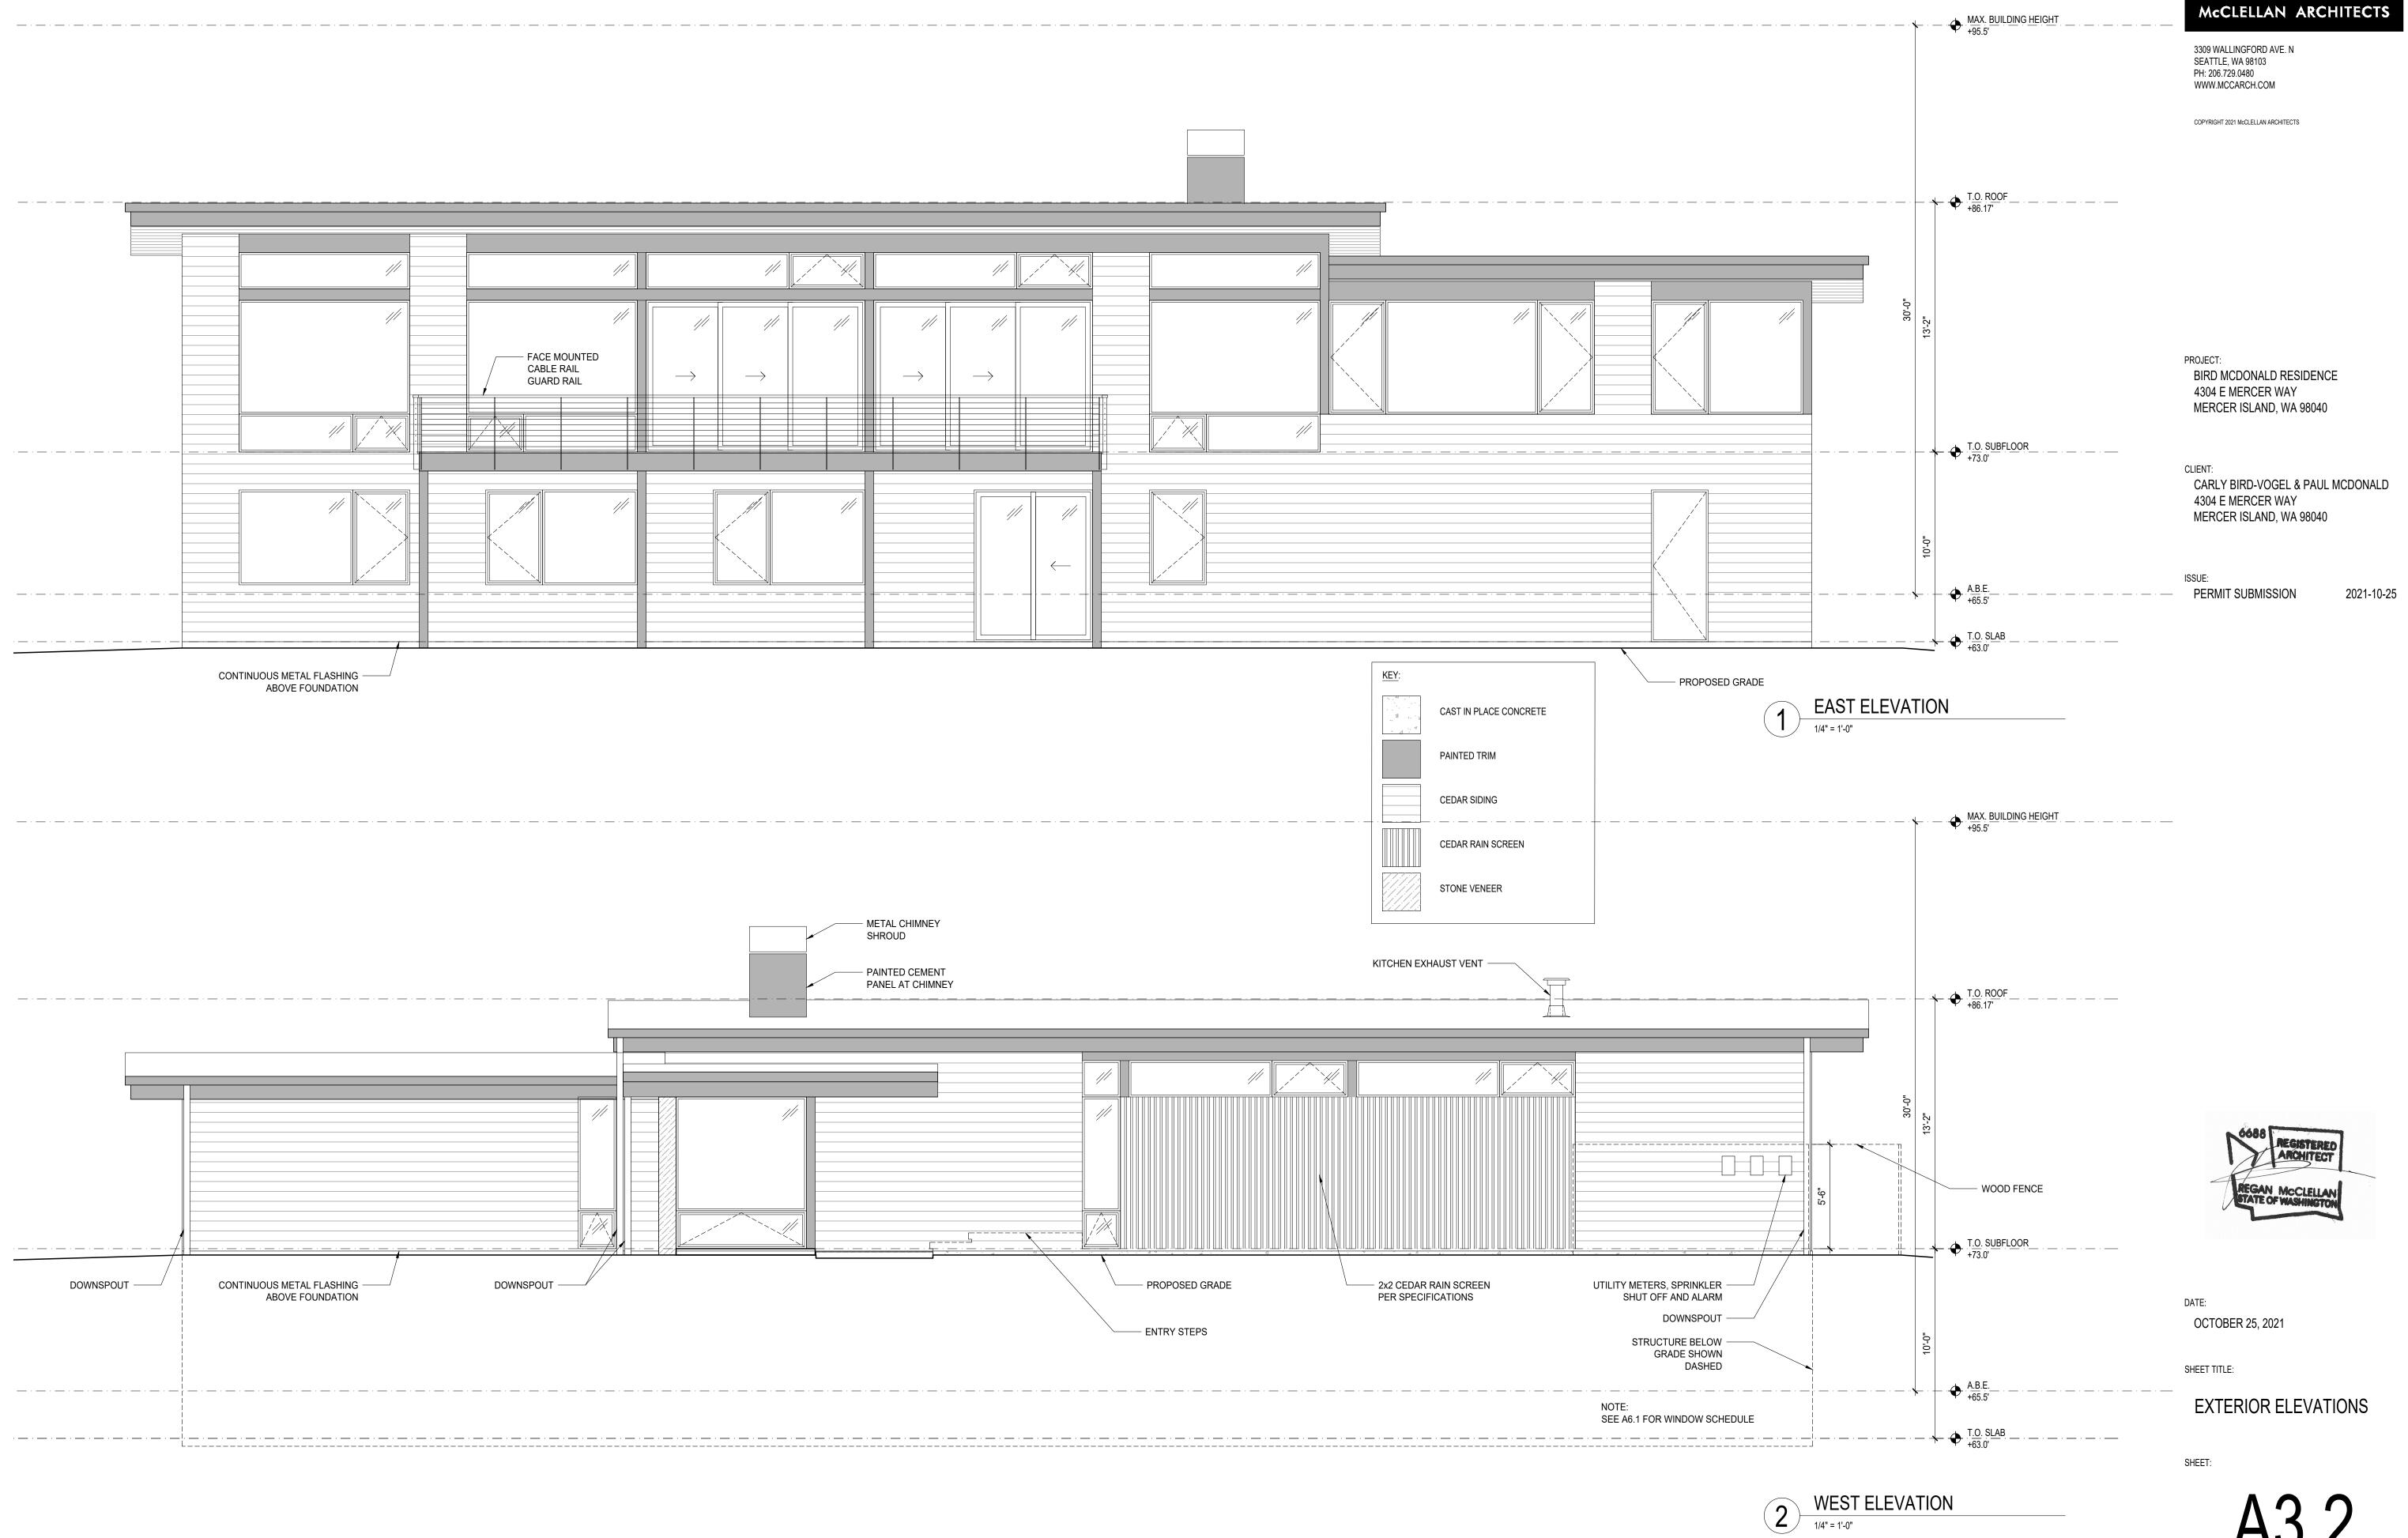
OCTOBER 25, 2021

SHEET TITLE:

ROOF PLAN


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T.O. SUBFLOOR +73.0'

T.O. SLAB +63.0'


BUILDING SECTION

1/4" = 1'-0"

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GARAGE

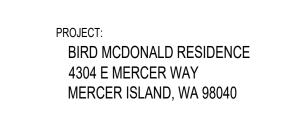101 UNHEATED BEDROOM

207

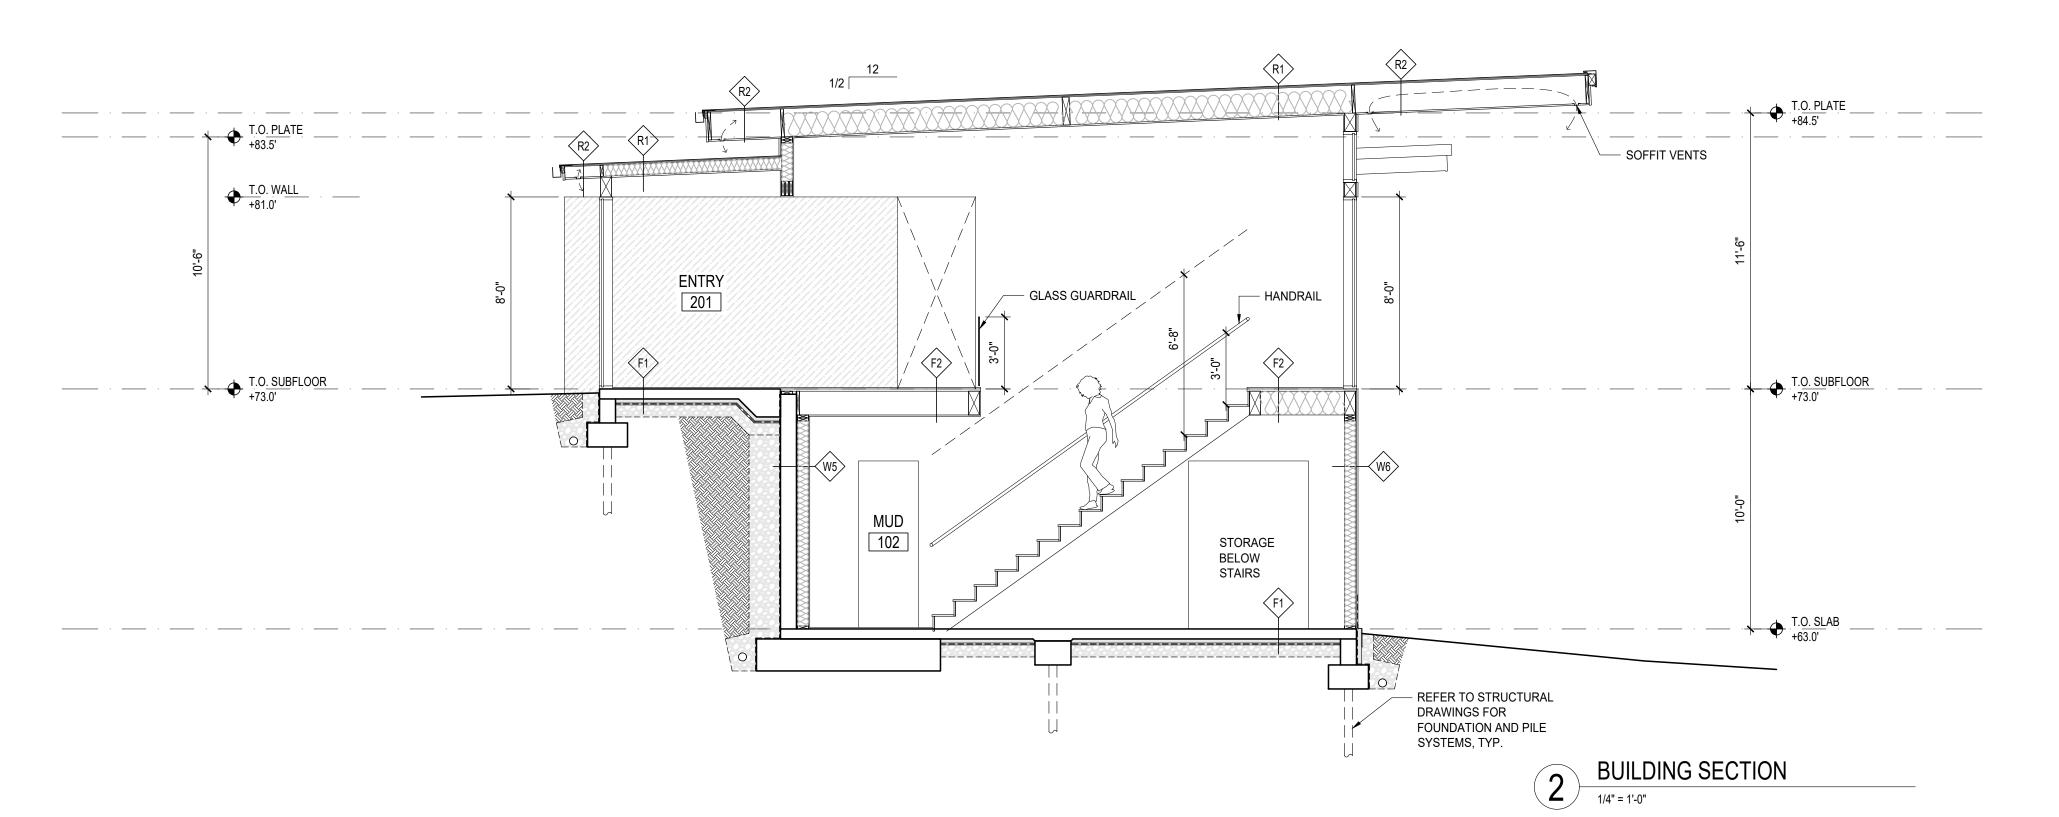HALL

210

CLOSET

209

T.O. SUBFLOOR +73.0' SOFFIT VENTS

REFER TO STRUCTURAL
 DRAWINGS FOR
 FOUNDATION AND PILE
 SYSTEMS, TYP.




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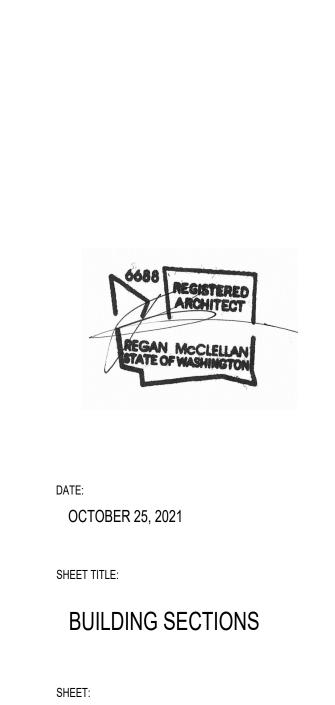
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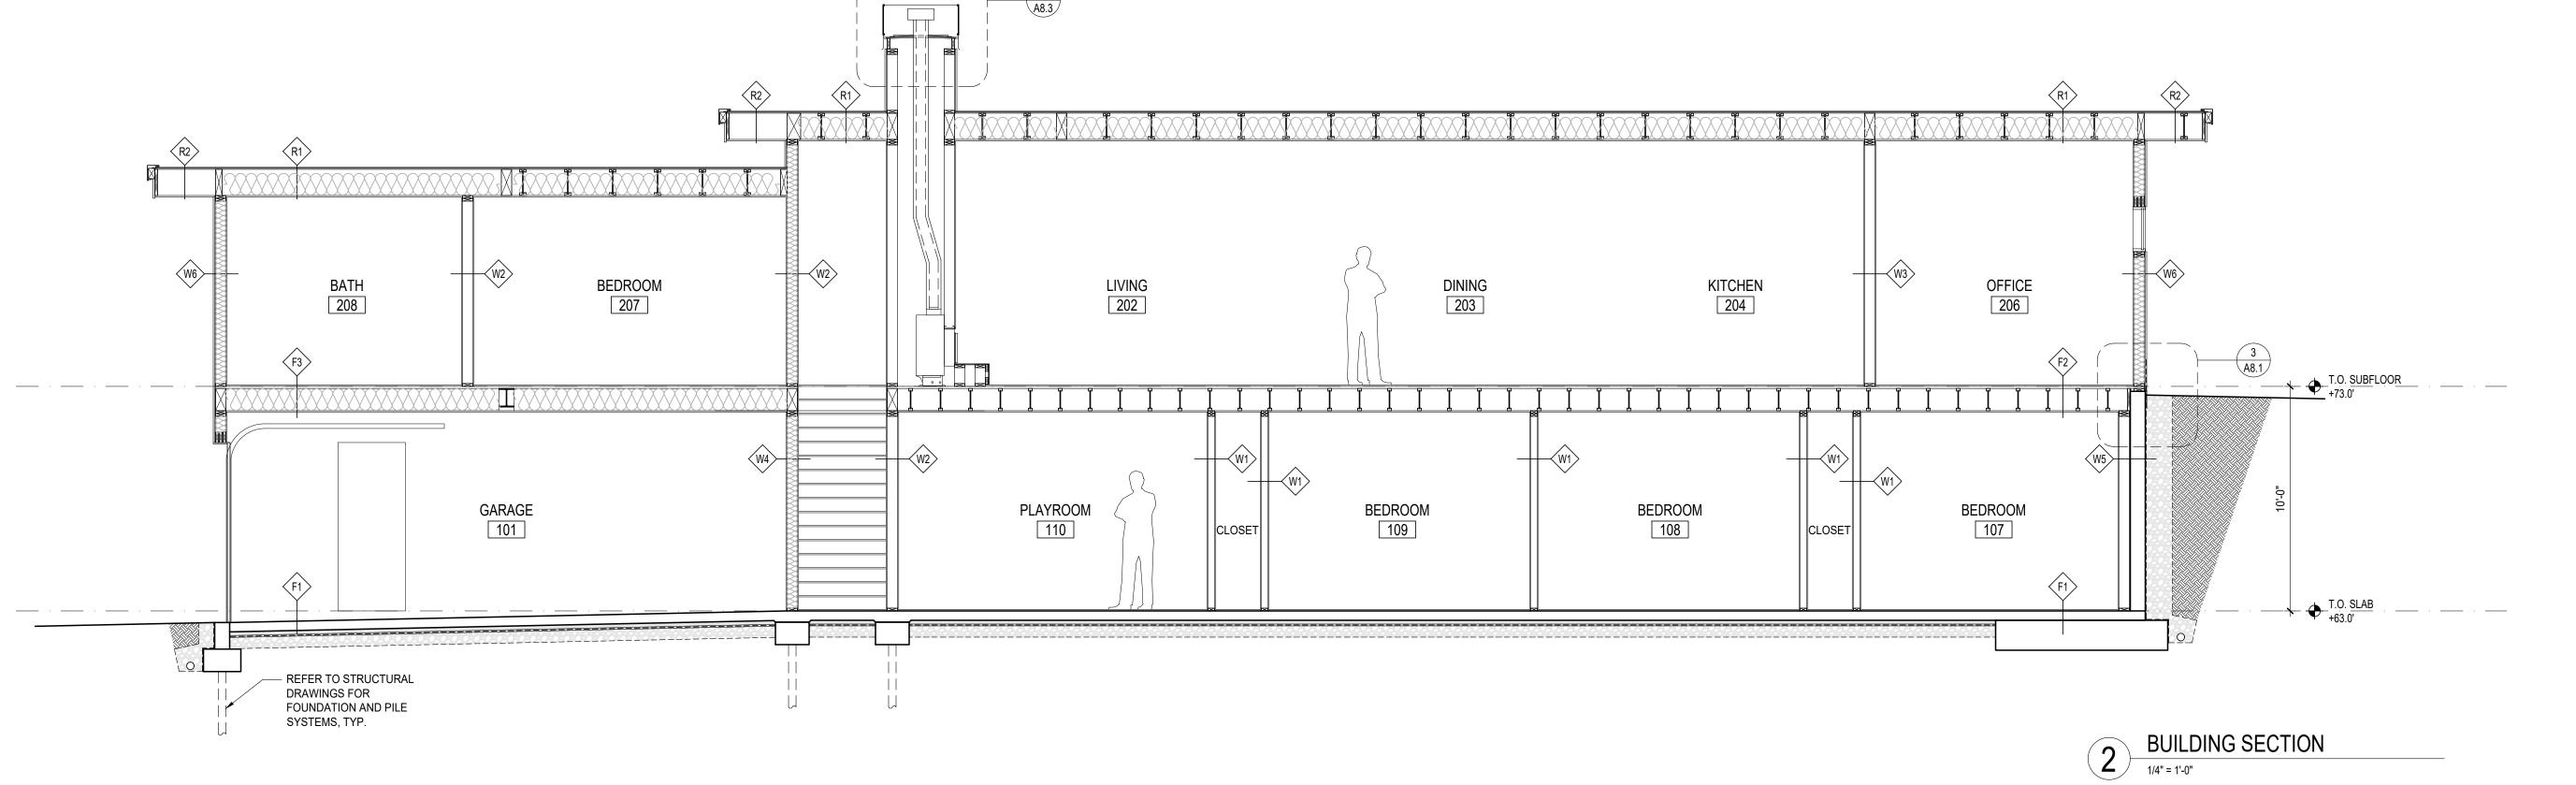
BUILDING SECTIONS

SHEET:

A4.1






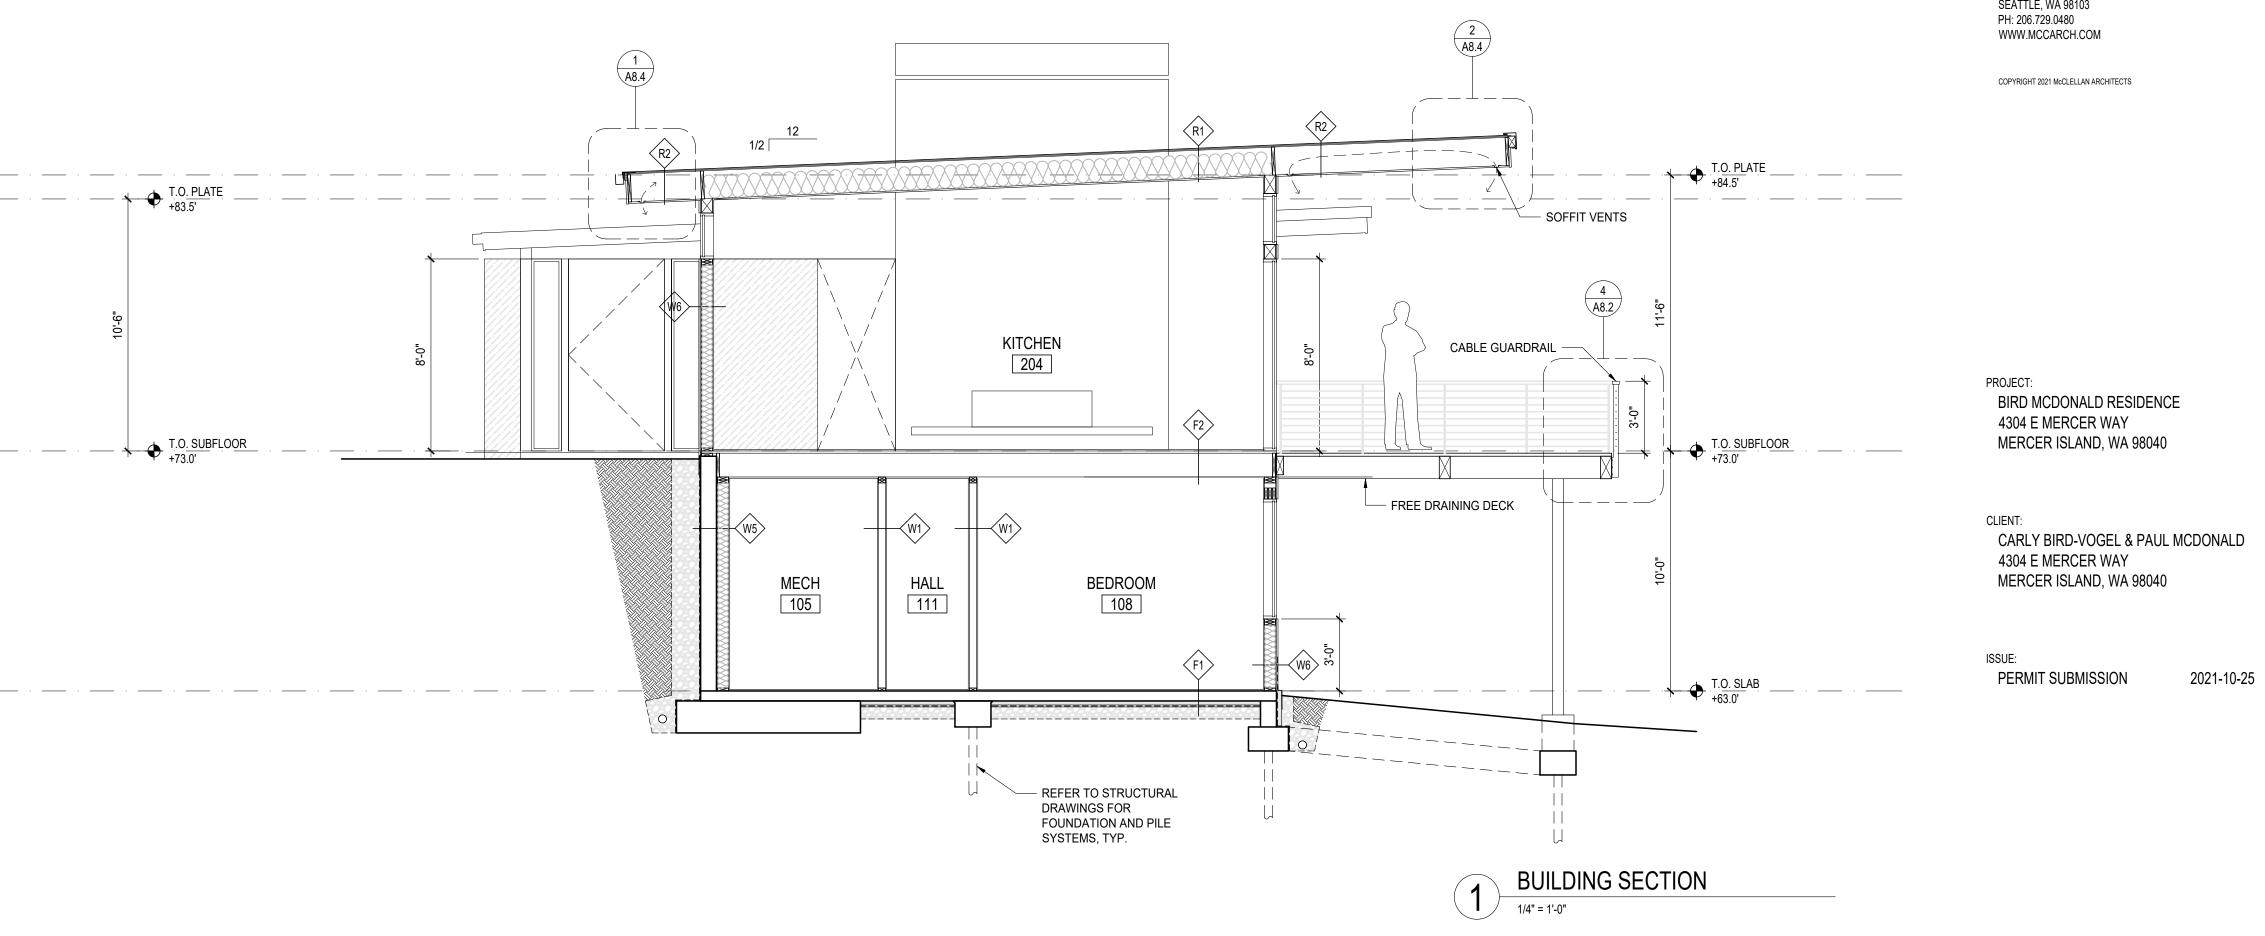


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A5.1

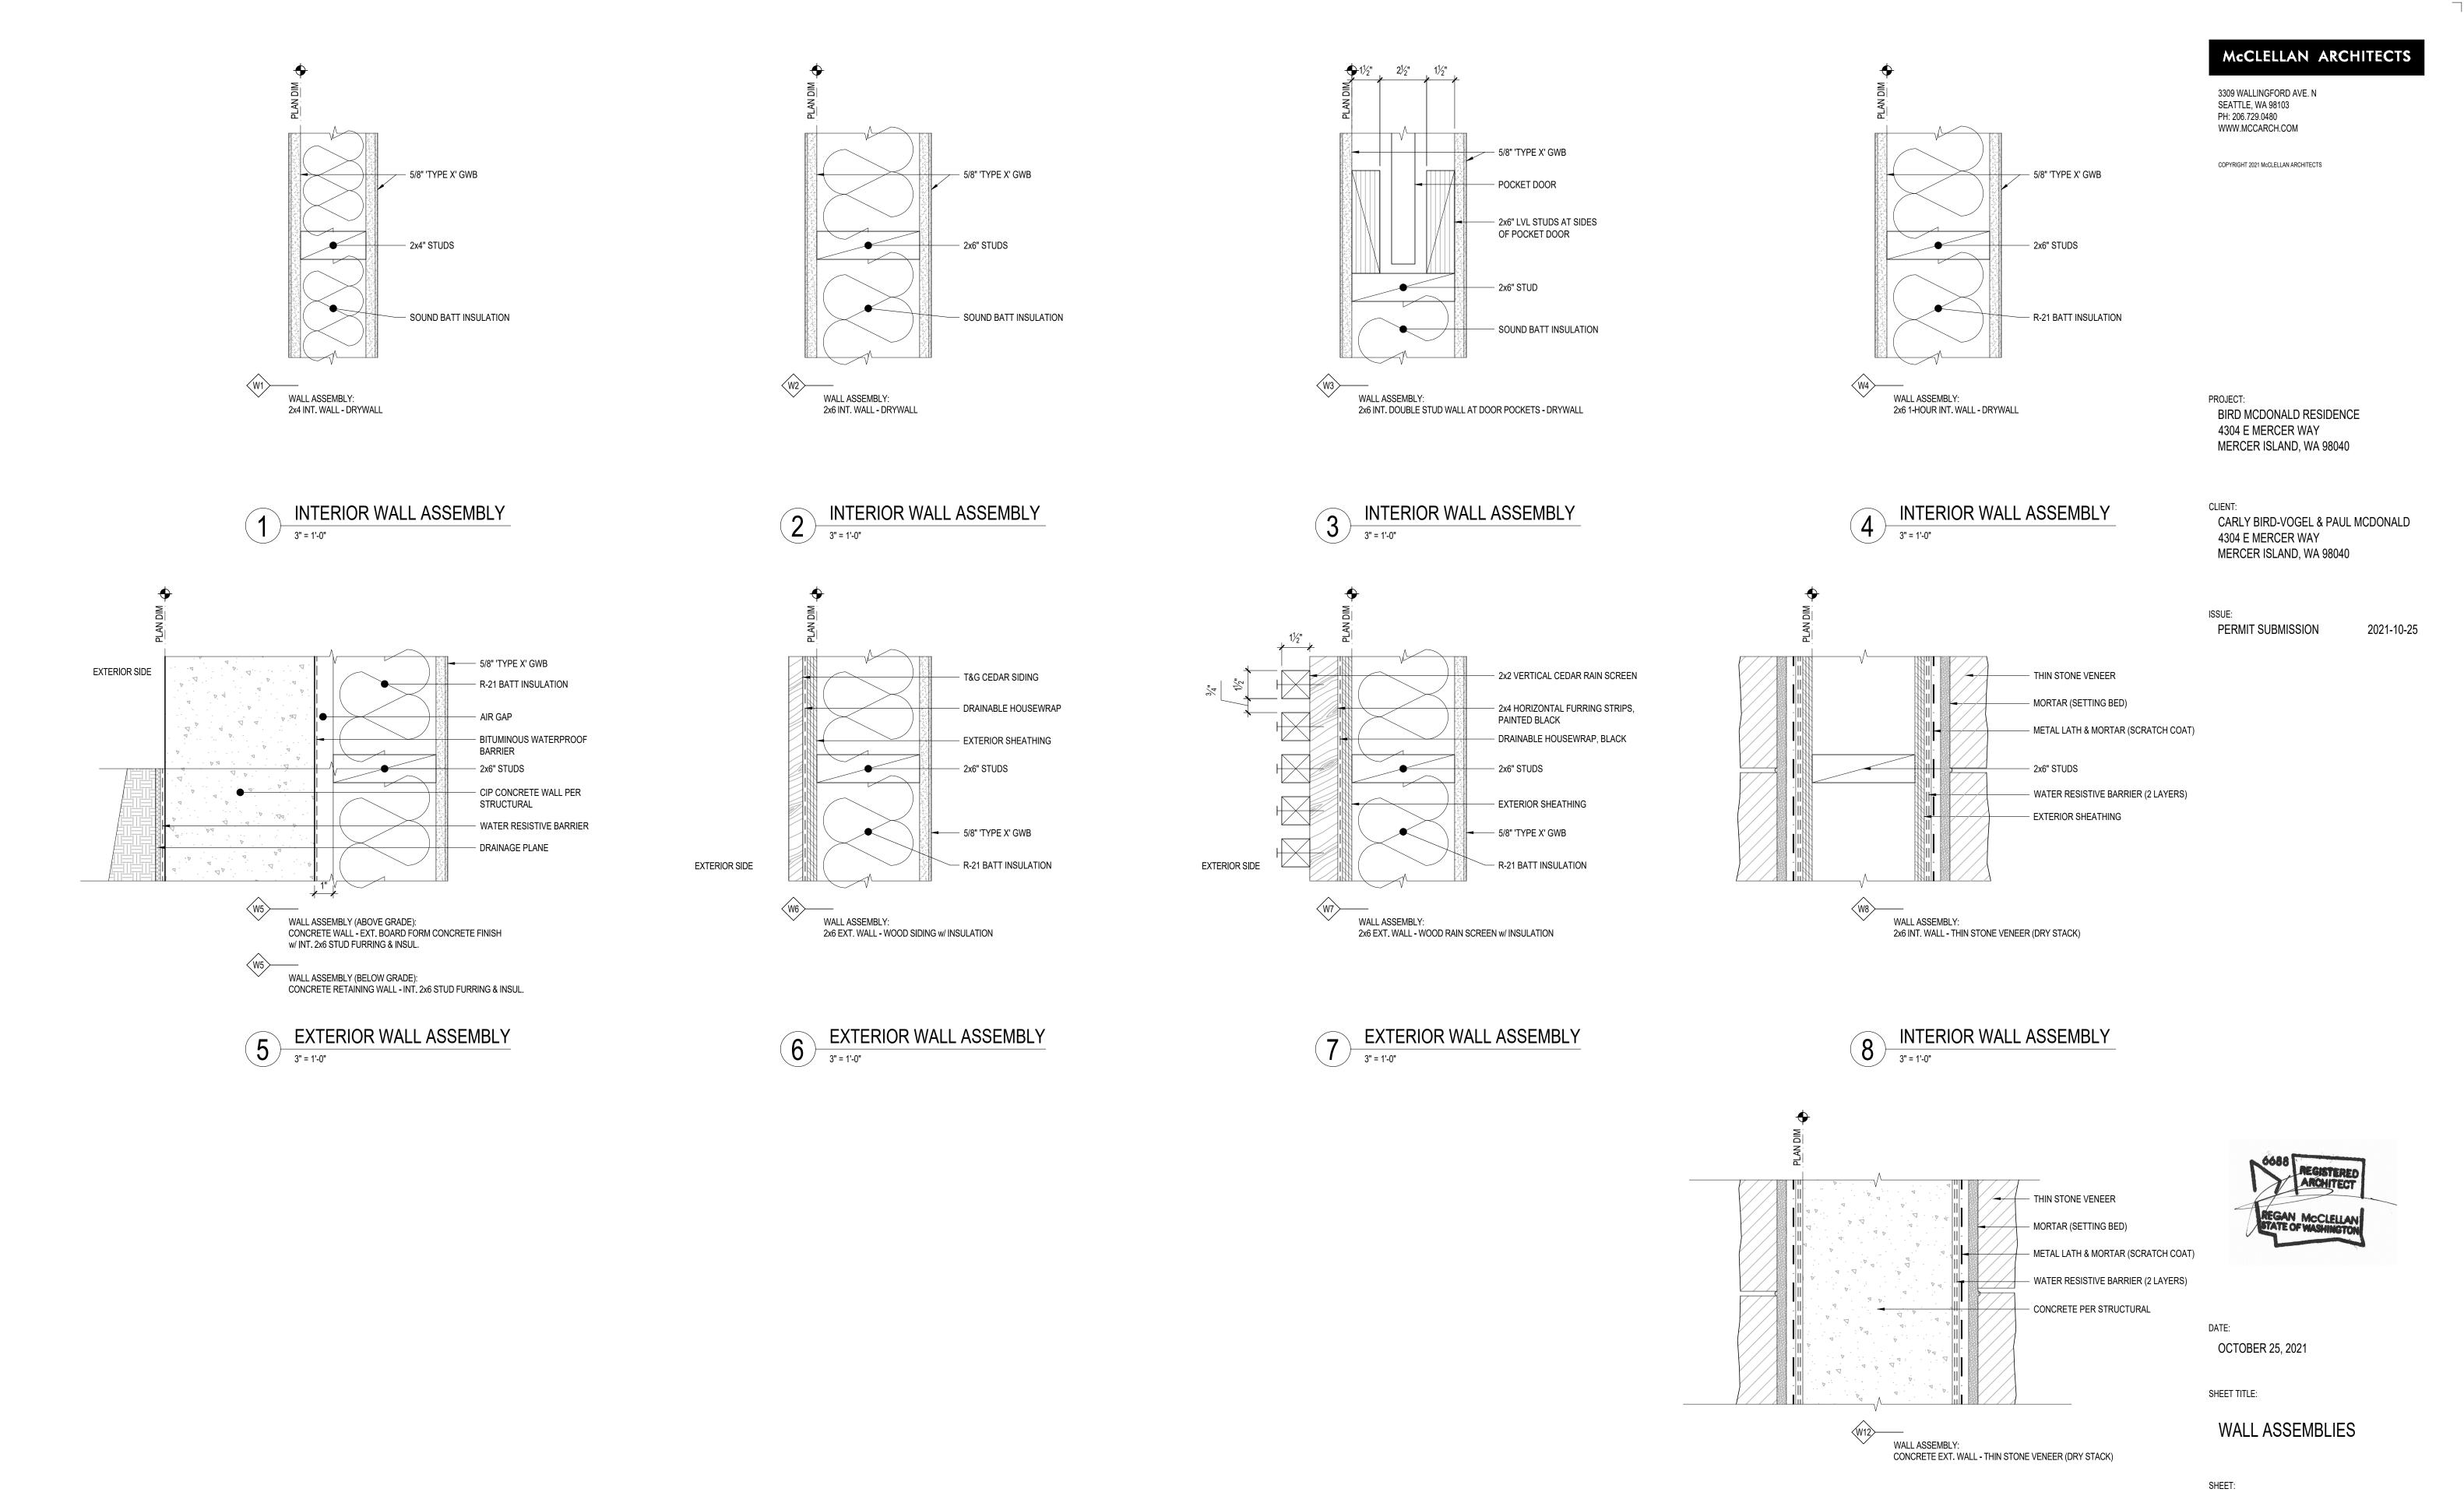

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DATE:


OCTOBER 25, 2021

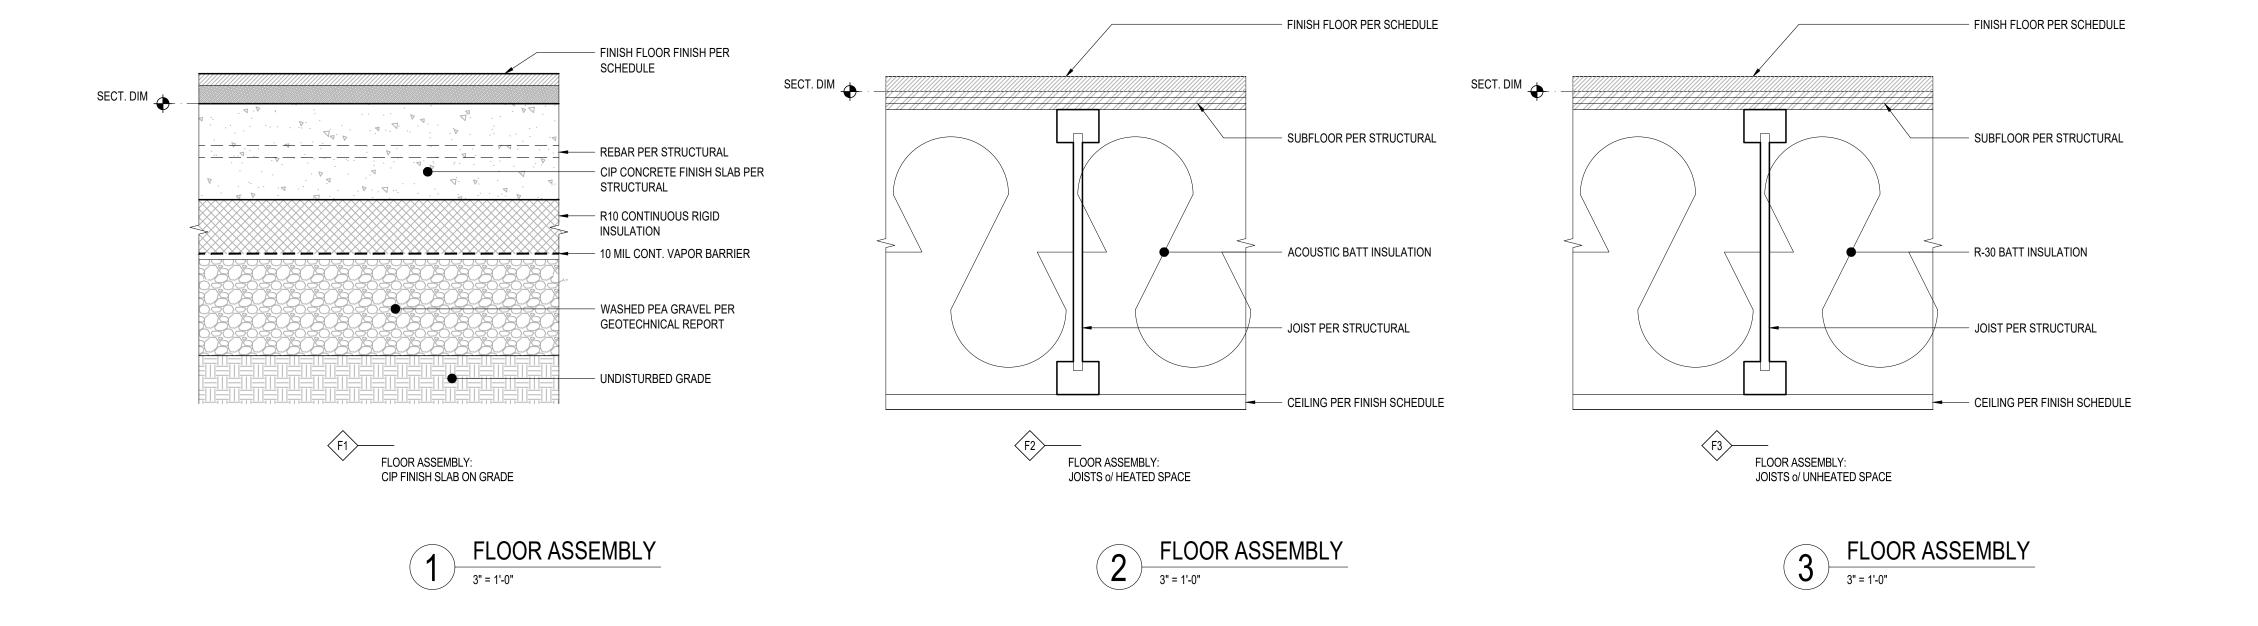SHEET TITLE:

FLOOR ASSEMBLIES

SHEET

A5.2

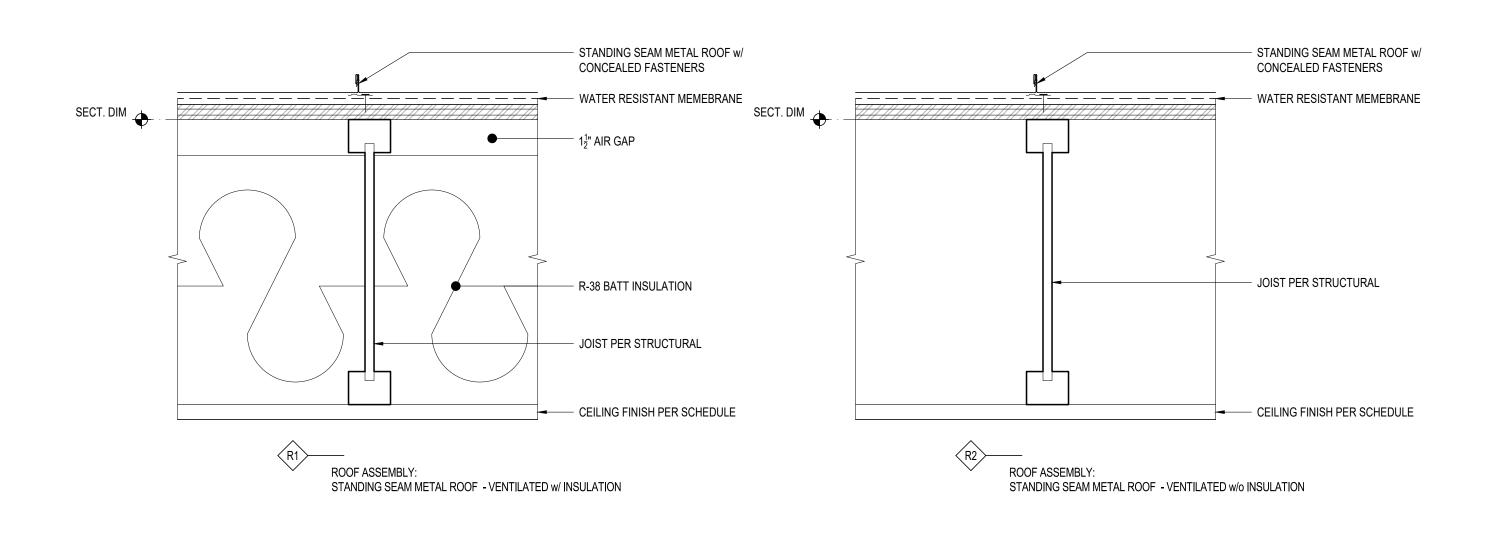

ROOF ASSEMBLY
3" = 1'-0"

ROOF ASSEMBLY

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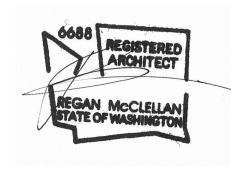
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CLIENT:

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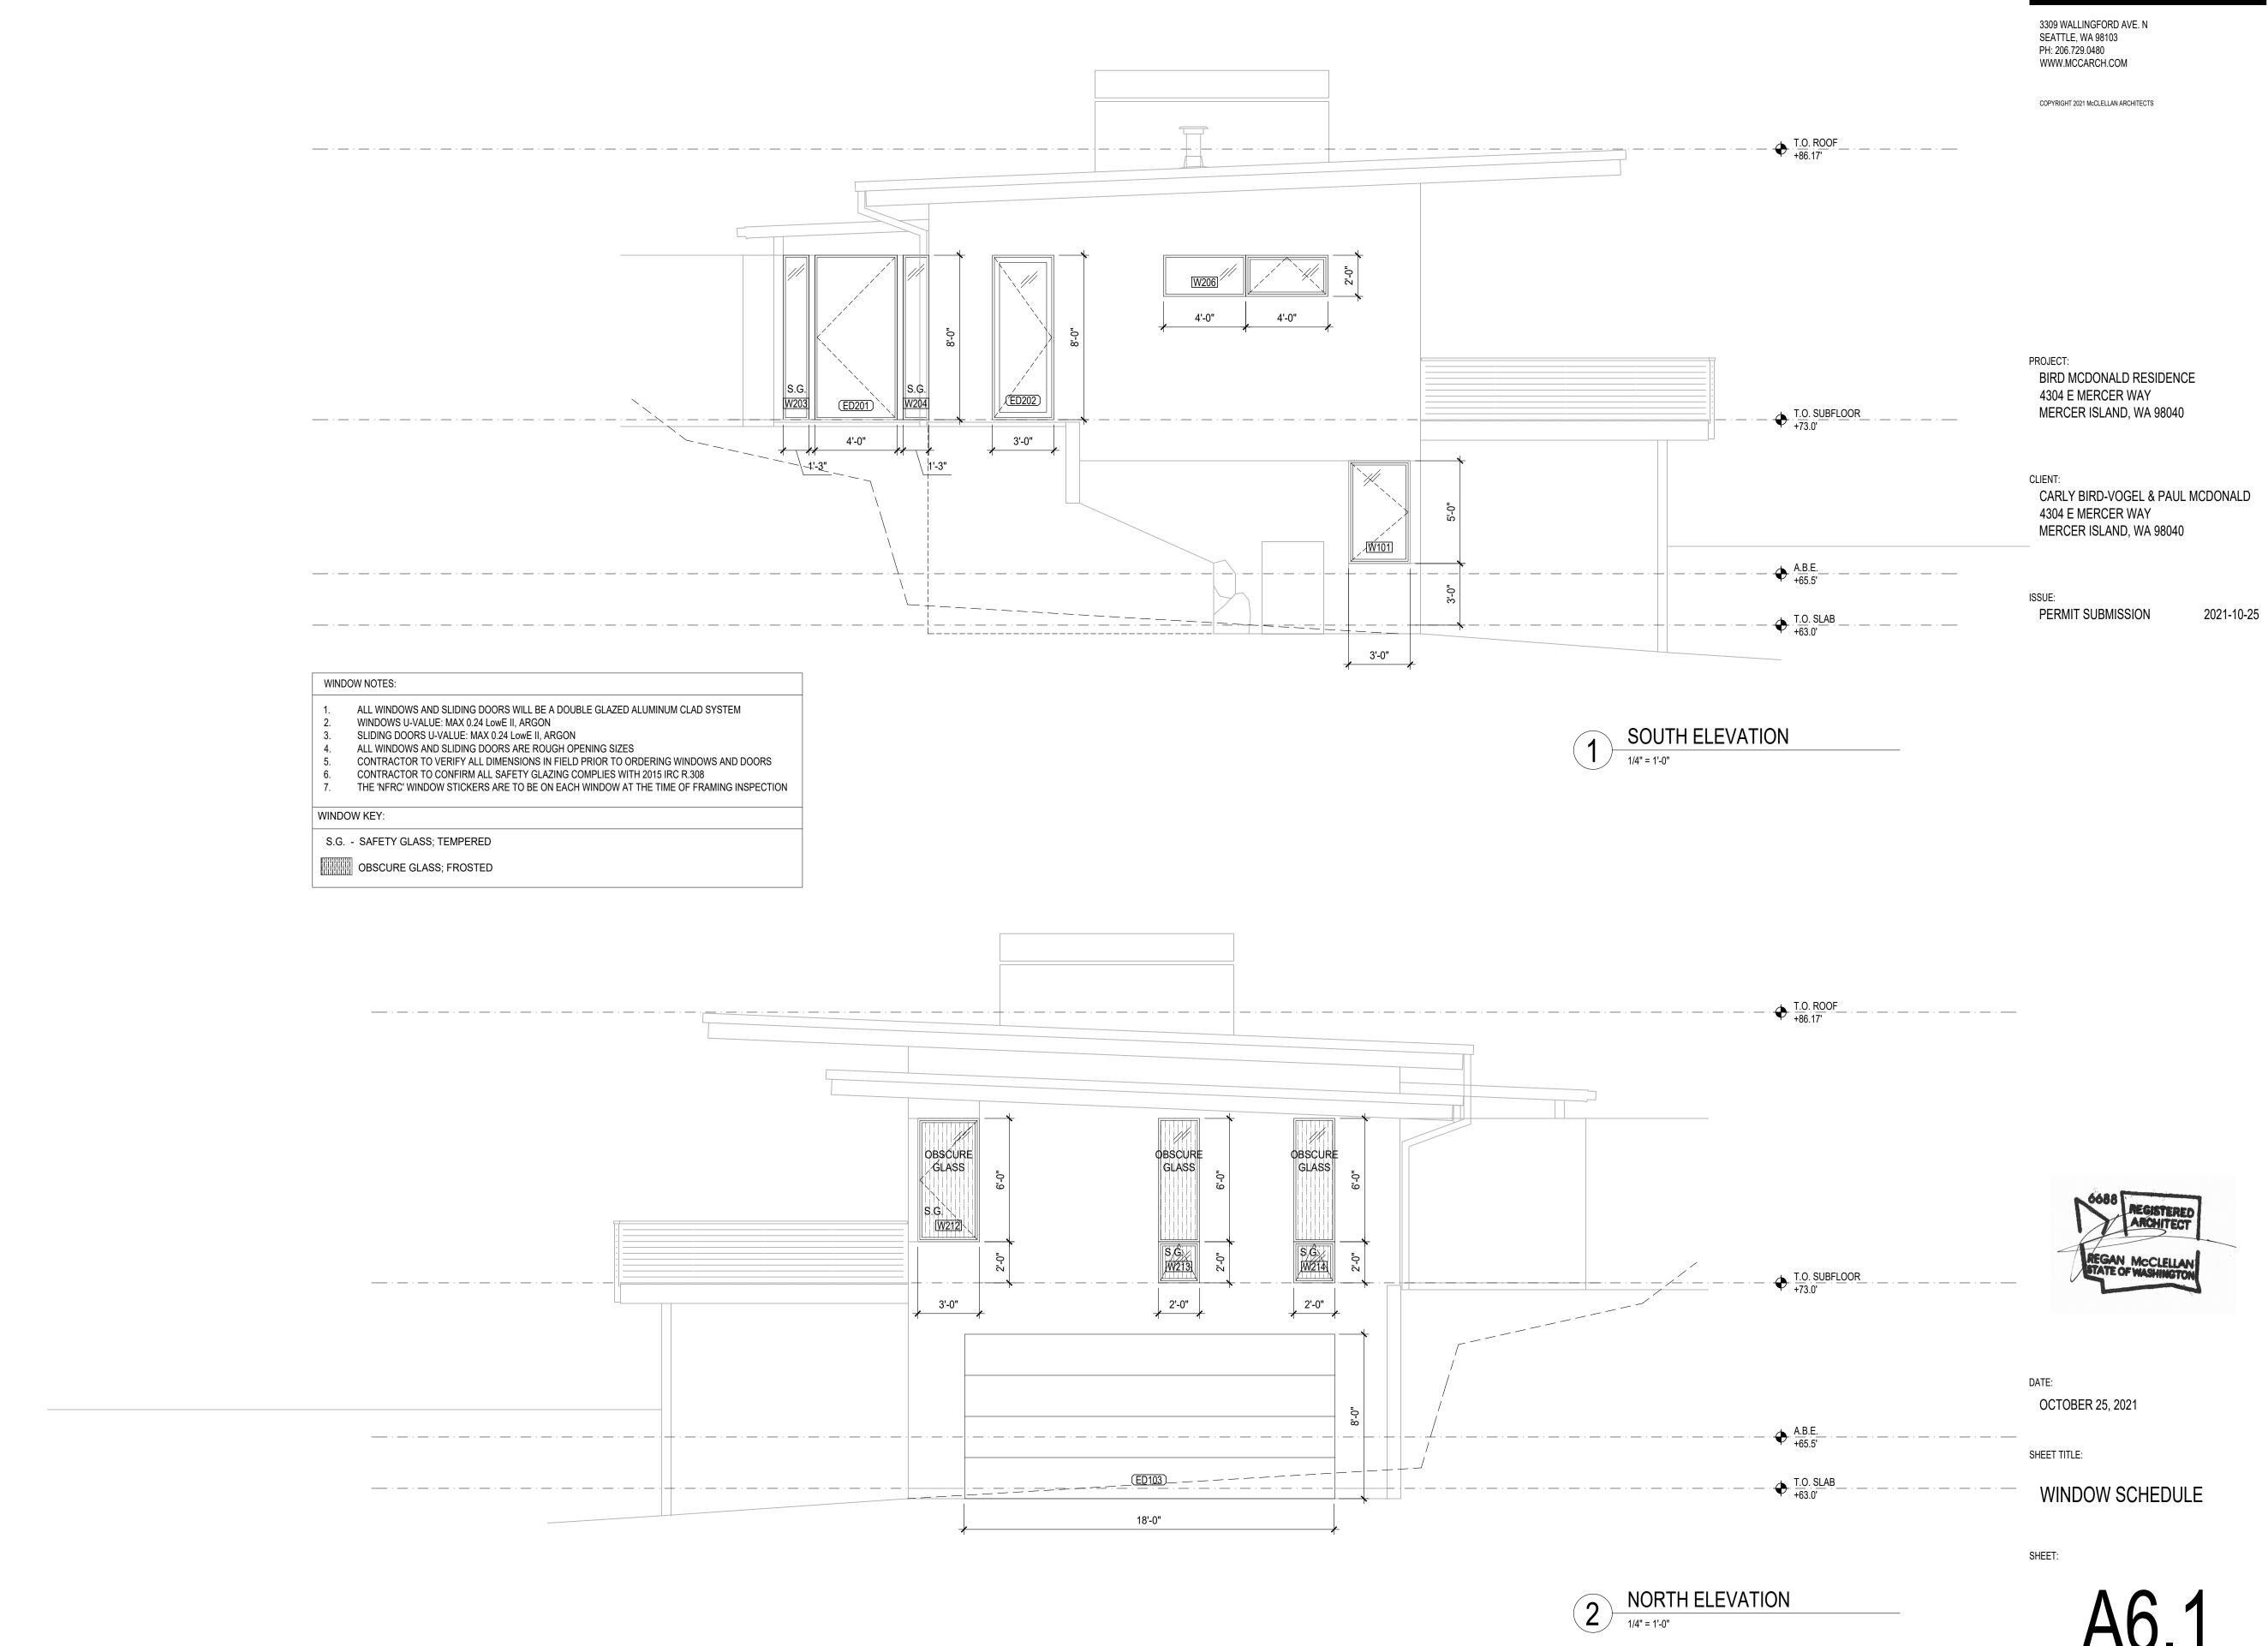
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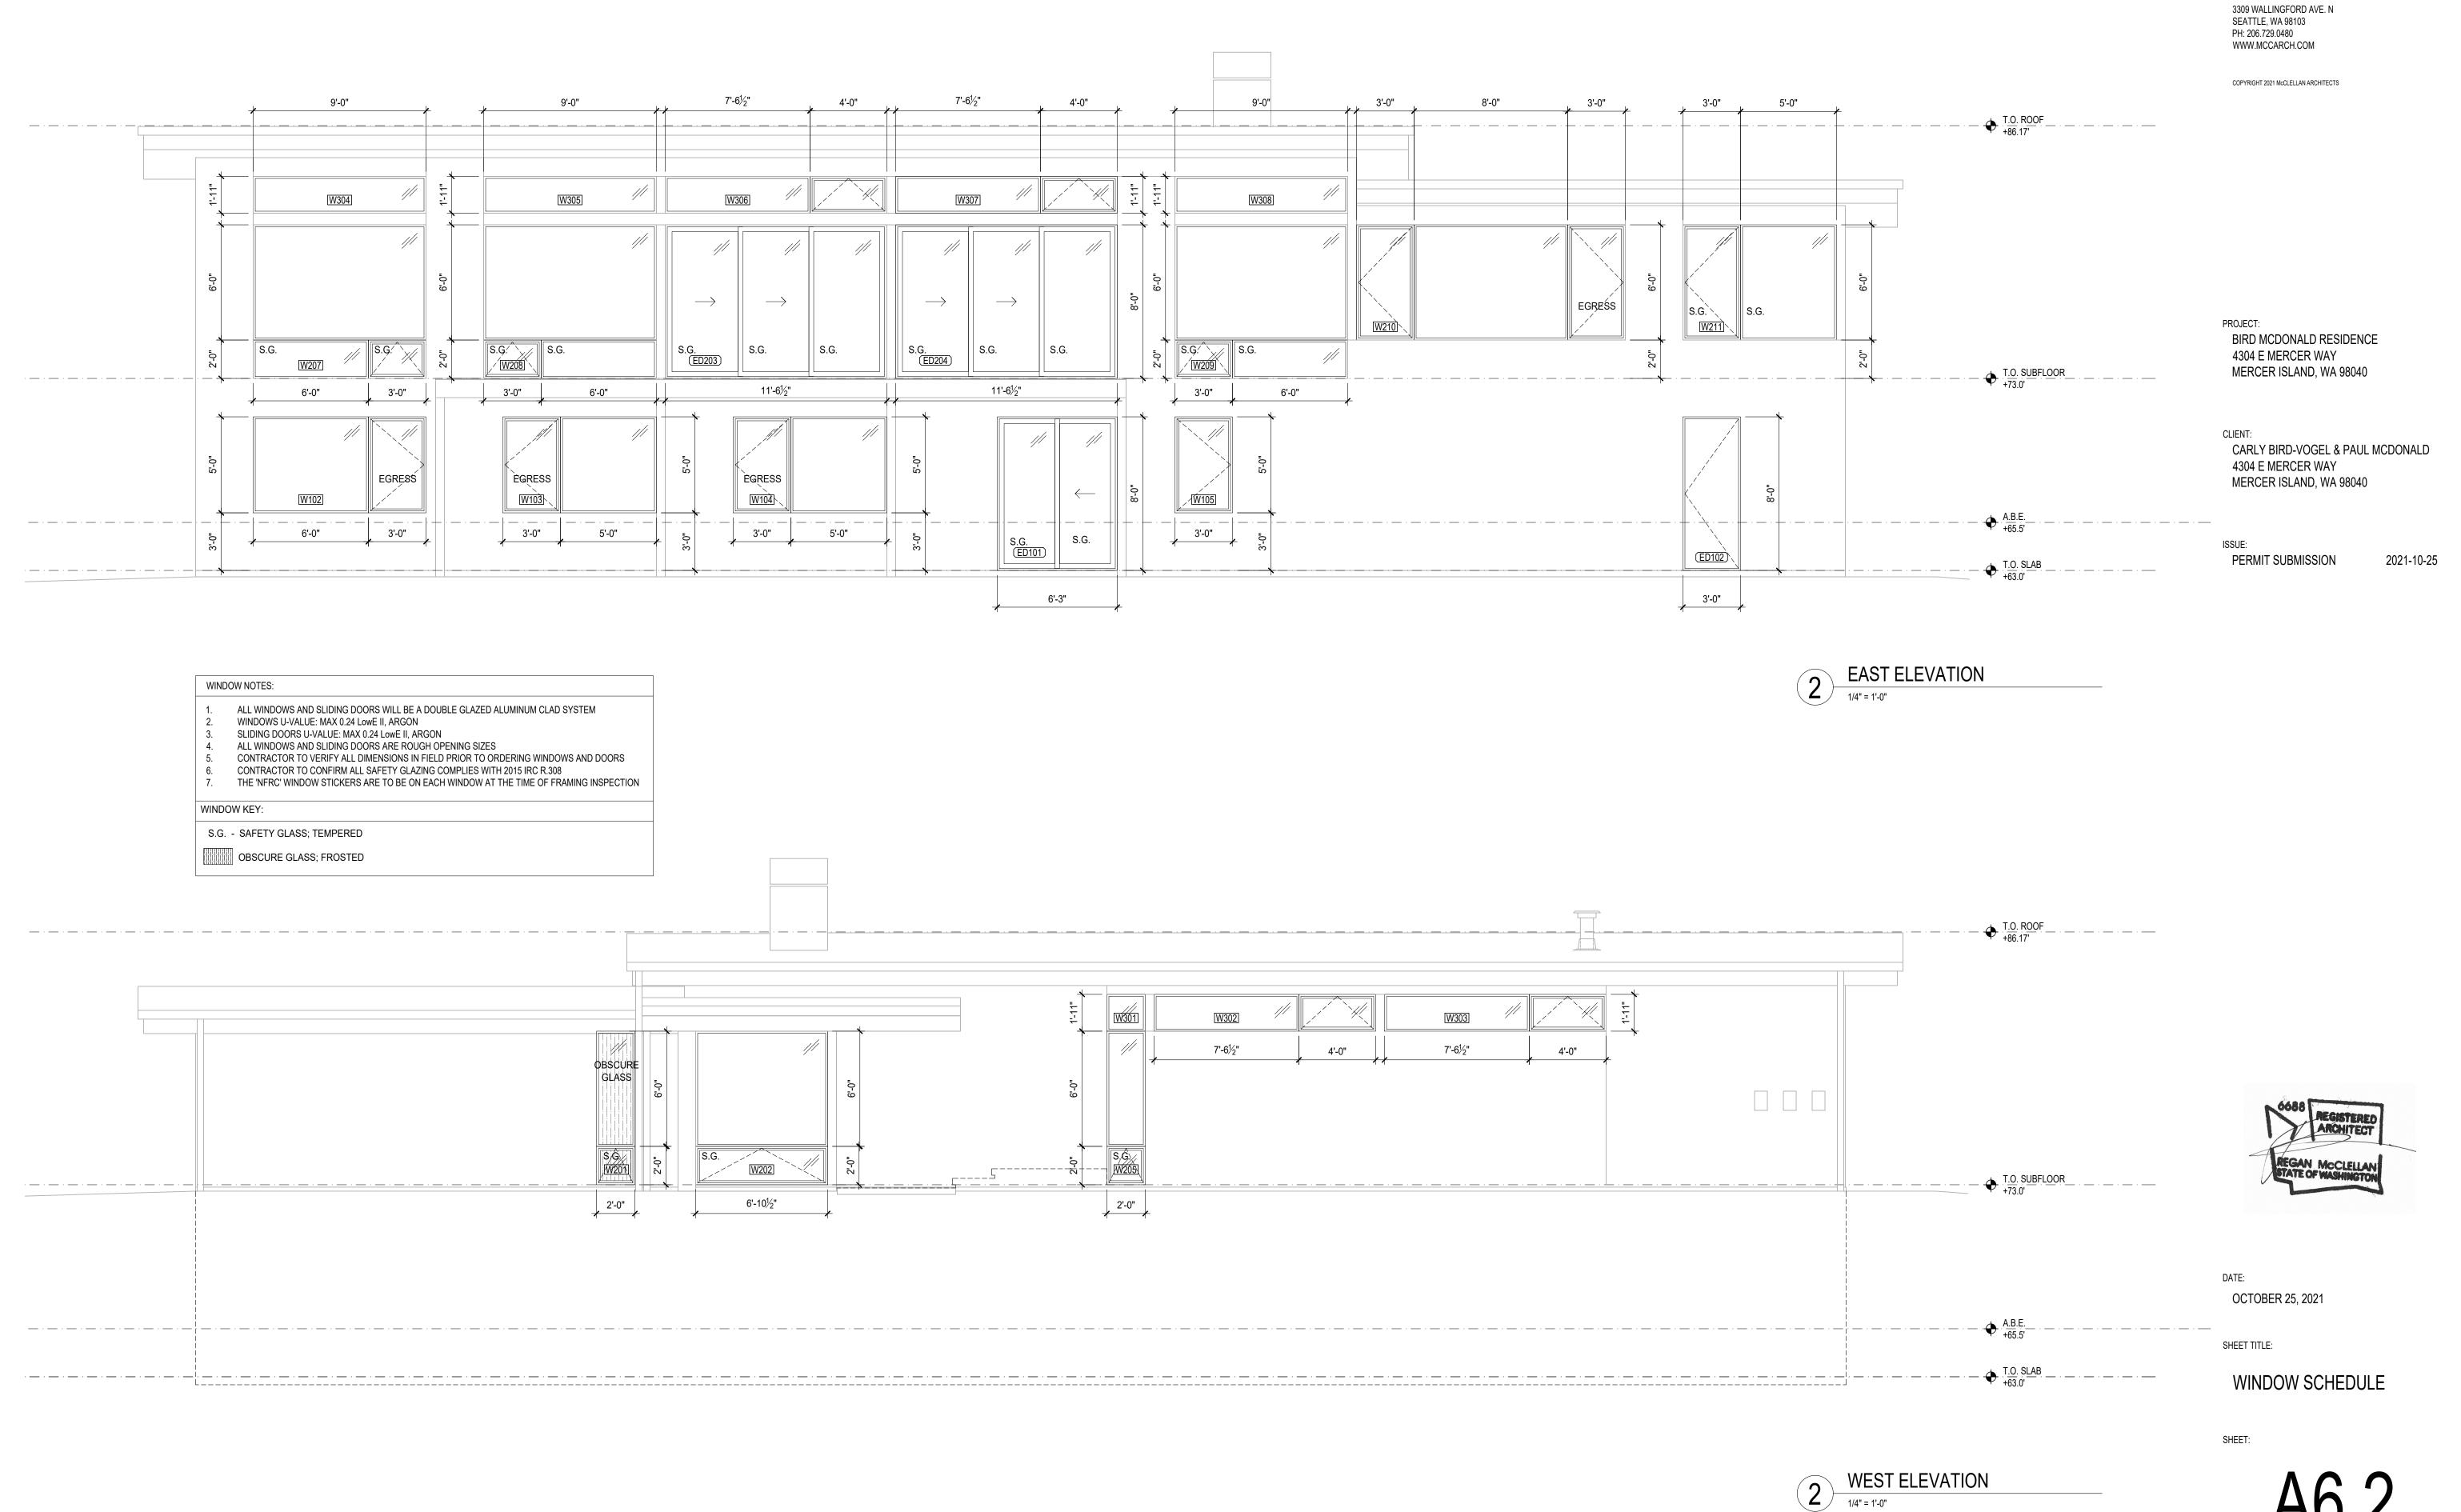


OCTOBER 25, 2021

SHEET TITLE:

ROOF ASSEMBLIES





WRITTEN DIMENSIONS:


1. WRITTEN DIMENSIONS ON THIS DRAWING SHALL HAVE PRECEDENCE OVER SCALED DIMENSIONS. CONTRACTOR SHALL VERIFY ALL DIMENSIONS, CONDITIONS, ETC. PERTAINING TO THE WORK BEFORE PROCEEDING. THE OWNER MUST BE NOTIFIED OF ANY VARIATIONS FROM THE DIMENSIONS AND/OR CONDITIONS SHOWN ON THESE DRAWINGS. ANY SUCH VARIATIONS SHALL BE RESOLVED BY THE OWNER PRIOR TO PROCEEDING WITH THE WORK, OR THE CONTRACTOR SHALL ACCEPT FULL RESPONSIBILITY FOR THE COST TO RECTIFY SAME.


2. MATERIAL SELECTIONS & FINISHES DENOTED DEPICT DESIGN INTENT. CONTRACTOR TO VERIFY ALL SELECTIONS AND FINISHES W/ OWNER PRIOR TO ORDERING / INSTALLING THE SAME. TYPICAL.

BIDDER DESIGN NOTES:

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3. CONTRACTOR SHALL FOLLOW MANUFACTURER'S INSTALLATION INSTRUCTIONS, TYPICAL.



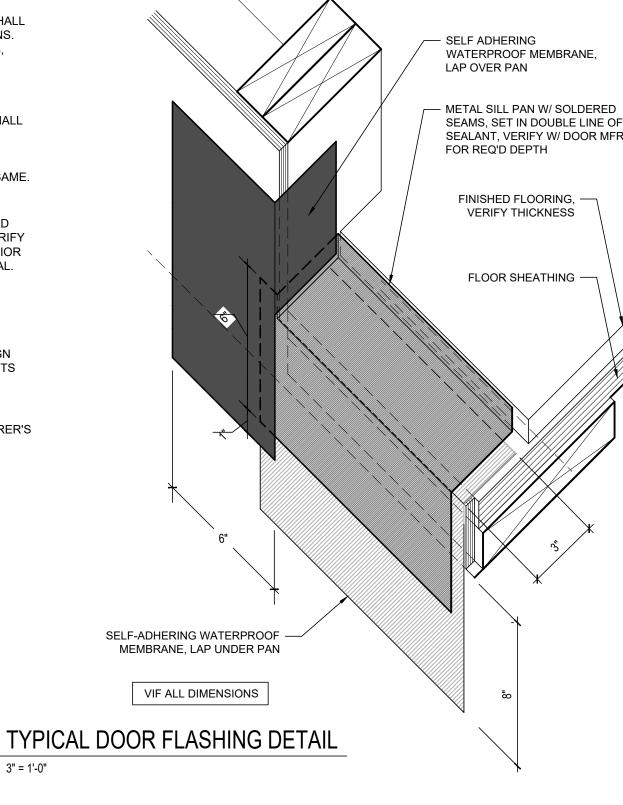

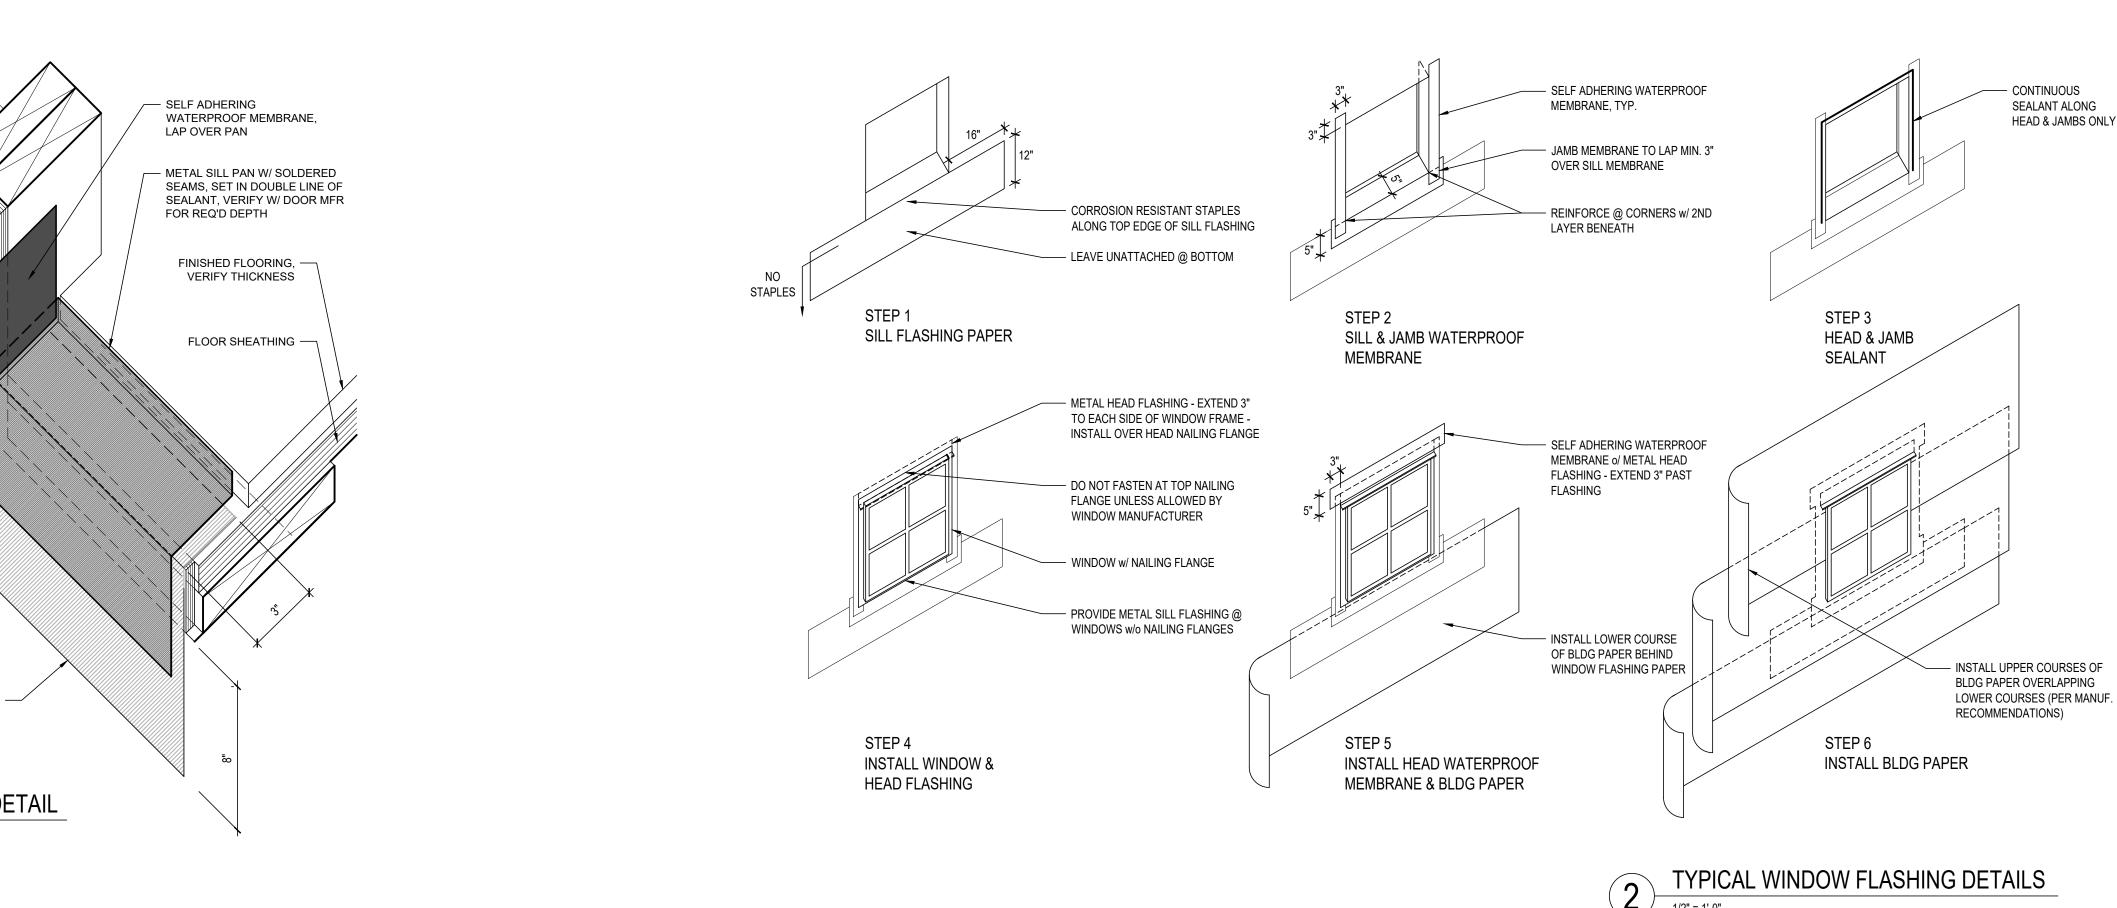WRB o/ FLASHING -

FLASHING

- PTD GWB FINISH

R-21 BATT INSULATION

- FOUNDATION WALL, PER

STRUCTURAL SLAB, PER

STRUCTURAL

- PT 2x4 FRAMING

STRUCTURAL

FOOTING PER

CONTINUOUS METAL -

LINE OF GRADE, SLOPE AWAY AT —

GEOTECH'S RECOMMENDATIONS, WRAP IN FILTER FABRIC ALONG PERIMETER OF FOUNDATION

CONTINUOUS WATERPROOFING -MEMBRANE AT BELOW GRADE

4" Ø FOOTING DRAIN, TIGHTLINE

TO STORM DRAIN PER CIVIL


FACES OF CONCRETE, TYP.

ALL LOCATIONS, TYP.

DRAINAGE COURSE PER -

DRAINAGE MAT

FILTER FABRIC

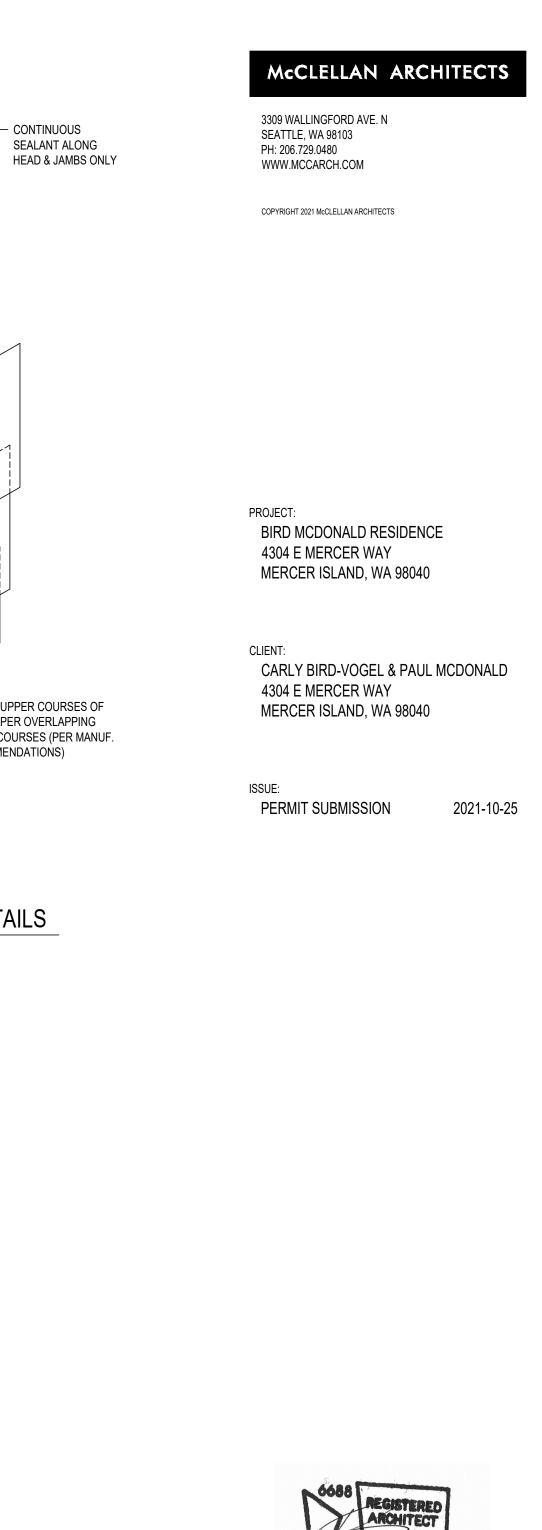



DATE: OCTOBER 25, 2021

CONTINUOUS R-10 RIGID

INSULATION BELOW SLAB

- DRAINAGE COURSE PER

GEOTECH'S RECOMMENDATIONS

TYP. FOOTING DETAIL

- 10 MIL POLY. VAPOR BARRIER

SHEET TITLE:

SHEET:

EXTERIOR DETAILS

WRITTEN DIMENSIONS:

1. WRITTEN DIMENSIONS ON THIS DRAWING SHALL HAVE PRECEDENCE OVER SCALED DIMENSIONS. CONTRACTOR SHALL VERIFY ALL DIMENSIONS, CONDITIONS, ETC. PERTAINING TO THE WORK BEFORE PROCEEDING. THE OWNER MUST BE NOTIFIED OF ANY VARIATIONS FROM THE DIMENSIONS AND/OR CONDITIONS SHOWN ON THESE DRAWINGS. ANY SUCH VARIATIONS SHALL BE RESOLVED BY THE OWNER PRIOR TO PROCEEDING WITH THE WORK, OR THE CONTRACTOR SHALL ACCEPT FULL RESPONSIBILITY FOR THE COST TO RECTIFY SAME.

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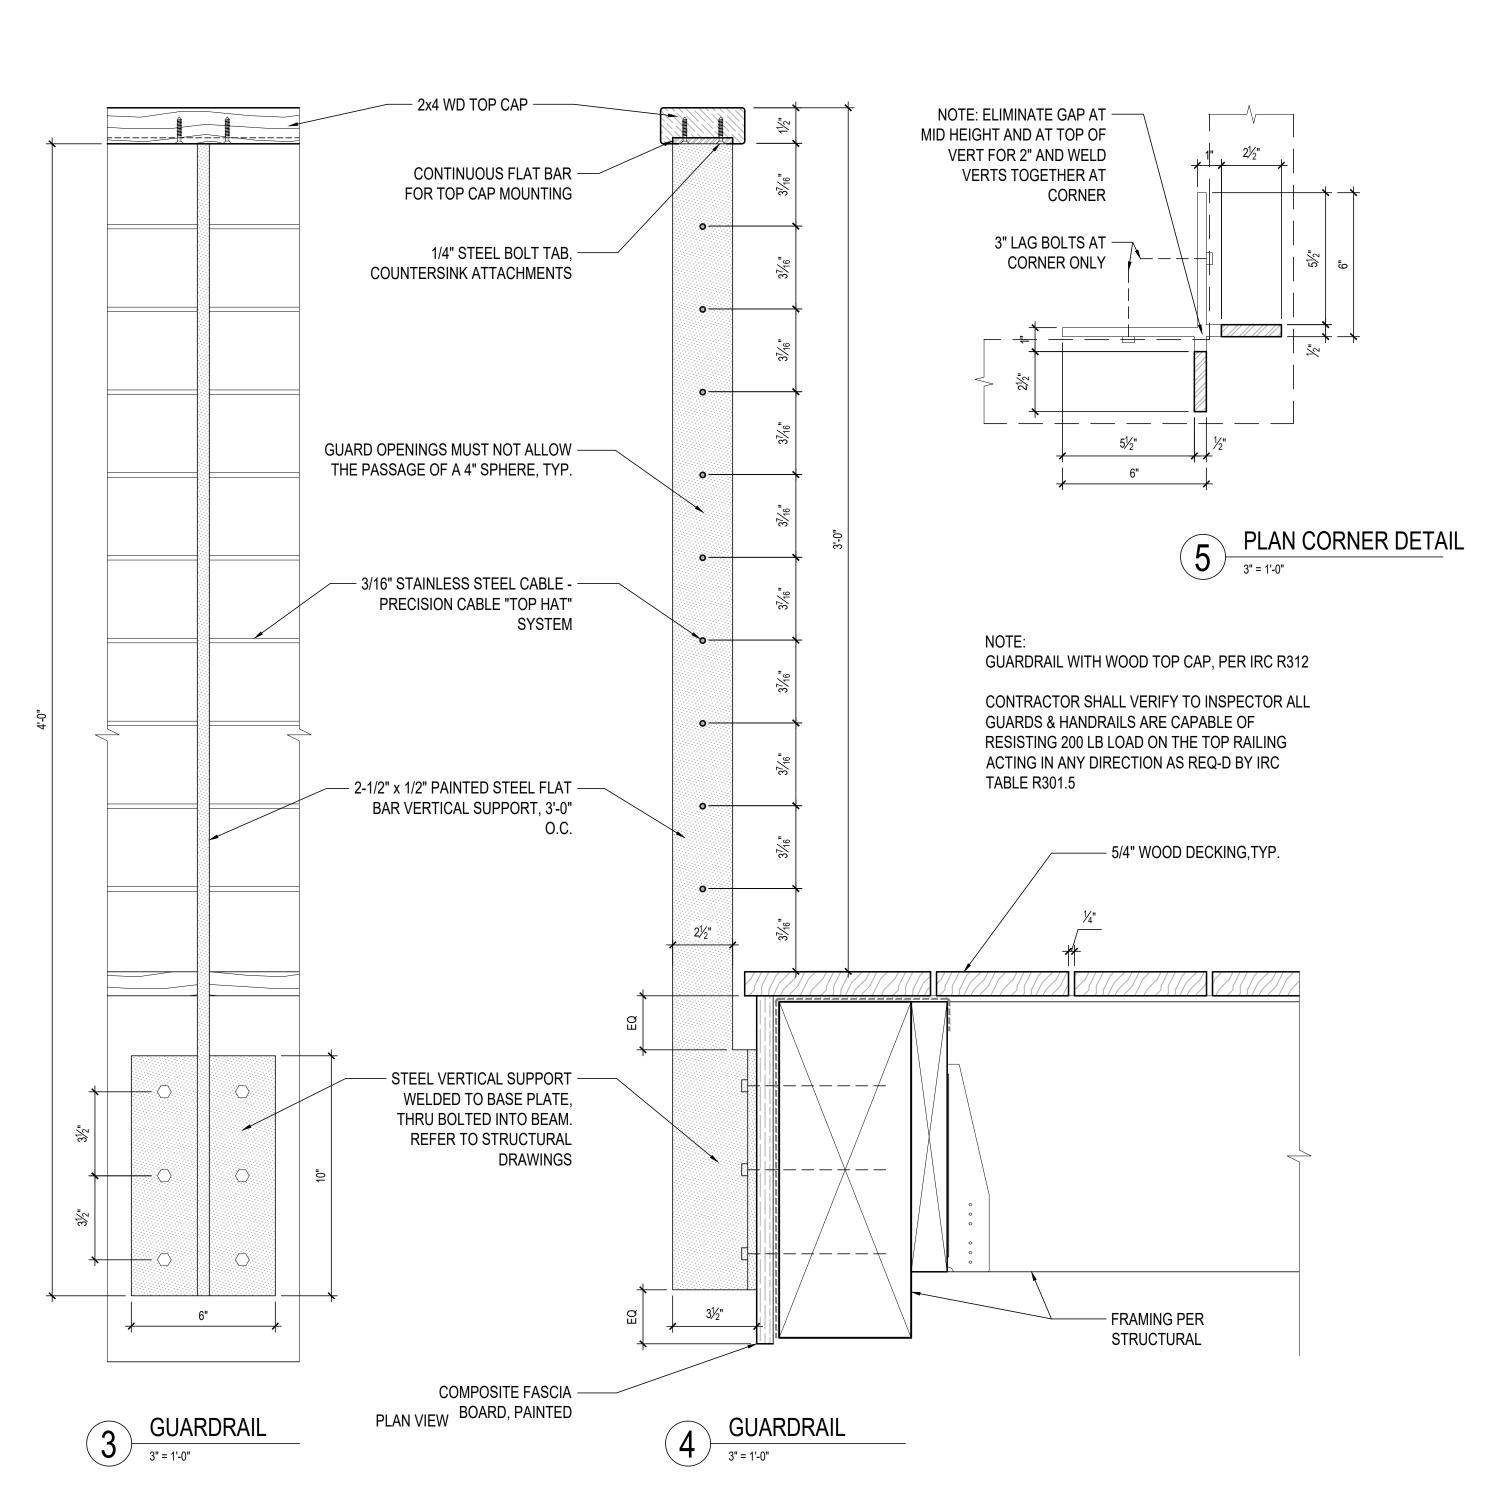
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PROJECT:
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4304 E MERCER WAY
MERCER ISLAND, WA 98040

CLIENT:

CARLY BIRD-VOGEL & PAUL MCDONALD 4304 E MERCER WAY MERCER ISLAND, WA 98040

ISSUE:

PERMIT SUBMISSION 2021-10-25

REGISTERED ARCHITECT

REGAN MCCLELLAN STATE OF WASHINGTON

DATE:


OCTOBER 25, 2021

SHEET TITLE:

RAILING DETAILS

SHEET:

A8.2

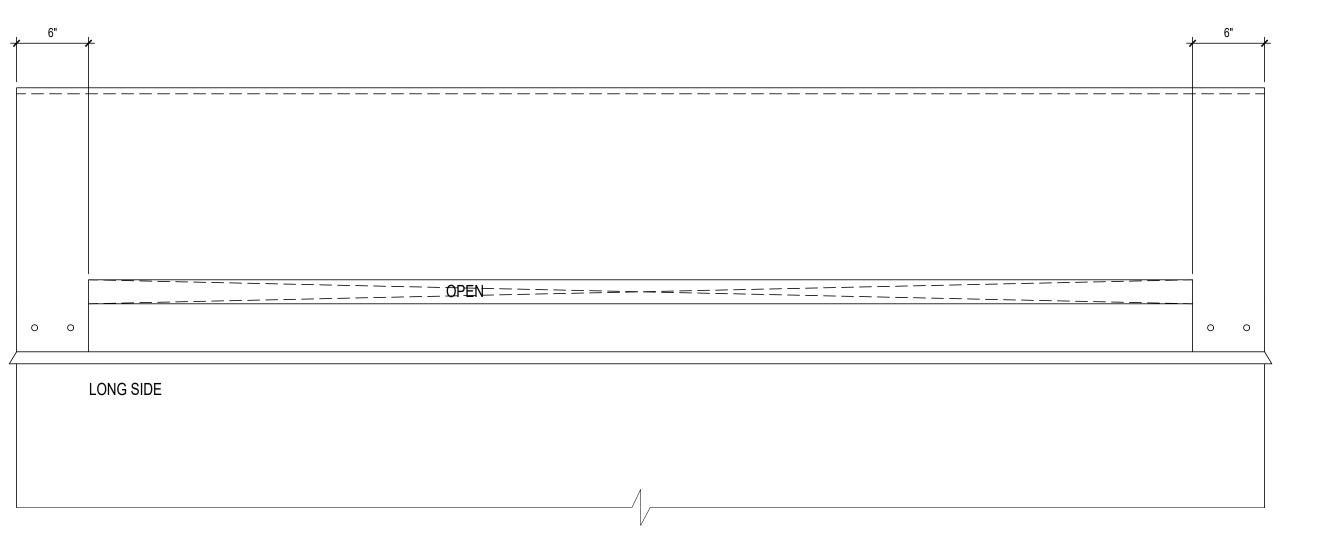

3 CHIMNEY SHROUD - LONG ELEV

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MERCER ISLAND, WA 98040


CLIENT:

CARLY BIRD-VOGEL & PAUL MCDONALD 4304 E MERCER WAY MERCER ISLAND, WA 98040

2021-10-25

ISSI IE:

PERMIT SUBMISSION

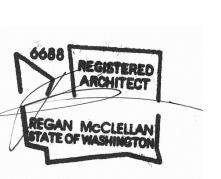

DATE:

OCTOBER 25, 2021

SHEET TITLE:

CHIMNEY SHROUD DETAILS

SHEET:

A8.3

WRITTEN DIMENSIONS:


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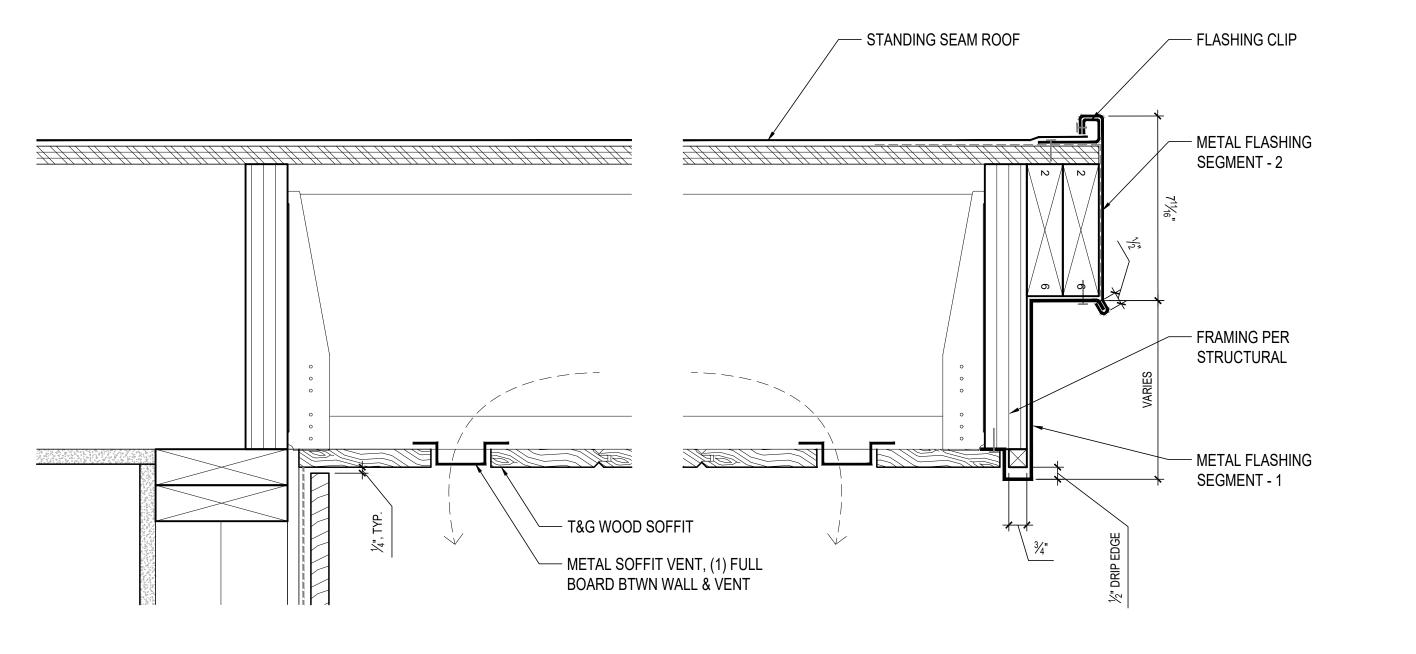
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3. CONTRACTOR SHALL FOLLOW MANUFACTURER'S INSTALLATION INSTRUCTIONS, TYPICAL.







TYP. RAKE / PEAK DETAIL

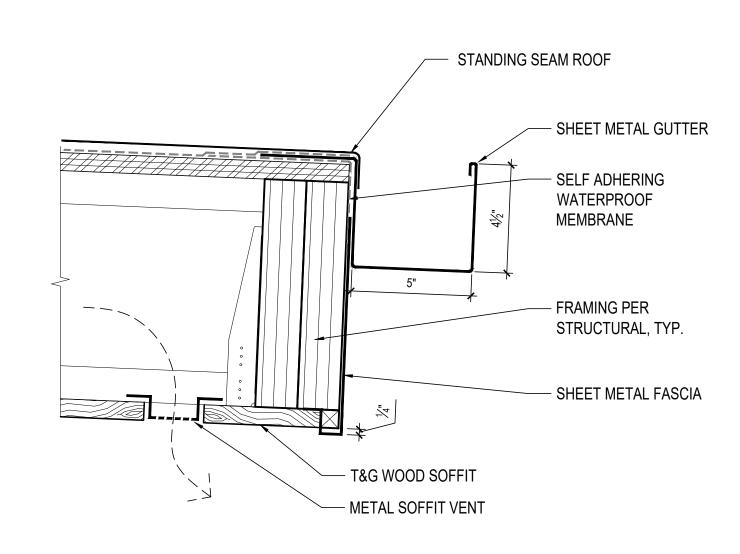3" = 1'-0"



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MERCER ISLAND, WA 98040

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DATE:

OCTOBER 25, 2021

SHEET TITLE:

ROOF DETAILS

SHEET:

A8.4

AD ANGUOD DOLT	ID INCIDE DIAMETED	GENERAL NOTES	
AB — ANCHOR BOLT ADDL — ADDITIONAL ALT — ALTERNATE ALUM — ALUMINUM ARCH — ARCHITECTURAL	ID — INSIDE DIAMETER IF — INSIDE FACE IN — INCHES INFO — INFORMATION	 ALL CONSTRUCTION MATERIALS AND WORKMANSHIP SHALL CONFORM TO THE REQUIREMENTS OF THE DRAWINGS, SPECIFICATIONS, AND THE CODES, RULES REGULATIONS OF THE 2015 EDITION OF THE INTERNATIONAL BUILDING CODE AS ADOPTED BY THE CITY OF MERCER ISLAND, WA. 	S AND
BLDG — BUILDING BLK (G) — BLOCK(ING)	INSUL — INSULATION JST — JOIST JT — JOINT L — LENGTH	THE CONTRACTOR SHALL VERIFY ALL DIMENSIONS PRIOR TO CONSTRUCTION. ARCHITECT SHALL BE NOTIFIED OF ANY DISCREPANCIES OR INCONSISTENCIES INCLUDES CONNECTION HARDWARE AND FASTENERS THAT MAY INTERFERE W	S. TH
BM(S) — BEAM(S) BO xxx — BOTTOM OF xxx BOT — BOTTOM BP — BASE PLATE	LLH – LONG LEG HORIZONTAL LLV – LONG LEG VERTICAL LOC – LOCATION	FINISHES OR OTHER ADJACENT SURFACES. 3. IF ANY ERRORS OR OMISSIONS APPEAR IN THESE DRAWINGS, SPECIFICATIONS	S,
BPC — BOTTOM PLATE CONNECTION BTWN — BETWEEN CIP — CAST IN PLACE	LT — LIGHT LSH — LONG SLOTTED HOLE MB — MACHINE BOLT	OR OTHER DOCUMENTS; THE CONTRACTOR SHALL NOTIFY THE STRUCTURAL ENGINEER OR ARCHITECT IN WRITING OF SUCH OMISSION OR ERROR BEFOR PROCEEDING WITH THE WORK.	
CJT - CONTRACTION/CONSTRUCTION JOINT CL - CENTERLINE CLR - CLEAR(ANCE) CMU - CONCRETE MASONRY UNIT COL - COLUMN	MECH — MECHANICAL MFR — MANUFACTURE(R/D) MIN — MINIMUM MISC — MISCELLANEOUS	4. NOTES AND DETAILS SHALL TAKE PRECEDENCE OVER GENERAL NOTES AND T DETAILS. WHERE NOTES AND DETAILS ON DRAWINGS AND THESE GENERAL AND TYPICAL DETAILS ARE IN CONFLICT, THE MOST STRINGENT SHALL APPLY. CONDITIONS NOT SPECIFICALLY SHOWI SHALL BE CONSTRUCTED AS SHOWN FOR SIMILAR WORK, SUBJECT TO REVIITHE ARCHITECT AND STRUCTURAL ENGINEER.	NOTES N
CONC — CONCRETE	NORM — NORMAL NO. — NUMBER	THE ANOTHER AND STRUCTURAL ENGINEER.	
CONN – CONNECTION CONST – CONSTRUCTION CONT – CONTINUOUS CONTR – CONTRACTOR	NS — NEAR SIDE NTS — NOT TO SCALE	 MANUFACTURED MATERIALS SHALL BE APPROVED BY THE ENGINEER OF RECC PRIOR TO THEIR USE. ALL REQUIREMENTS OF THOSE APPROVALS SHALL B FOLLOWED. 	
COORD — COORDINATE CP — COMPLETE PENETRATION CTR — CENTER(ED) D — DEPTH or DEEP	O/C — ON CENTER OD — OUTSIDE DIAMETER OF — OUTSIDE FACE OH — OPPOSITE HAND OPNG — OPENING OPP — OPPOSITE	6. ALL STRUCTURAL SYSTEMS THAT ARE TO BE COMPOSED OF MANUFACTURED COMPONENTS TO BE FIELD ERECTED SHALL BE APPROVED BY THE ENGINEE RECORD PRIOR TO THEIR USE AND SHALL BE SUPERVISED BY THE SUPPLIE DURING MANUFACTURING, DELIVERY, HANDLING, STORAGE, AND ERECTION IN ACCORDANCE WITH INSTRUCTIONS PREPARED BY THE SUPPLIER.	ER
DBL — DOUBLE DEG — DEGREE DEMO — DEMOLITION DET — DETAIL	OVS — OVERSIZED PAF — POWDER ACTUATED	 FRAMING MEMBERS WHICH ARE NOT DIMENSIONED SHALL BE EQUALLY SPACE BETWEEN DIMENSIONED POINT OR MEMBERS. 	ΞD
DIA — DIAMETER DIAG — DIAGONAL DIM — DIMENSION	FASTENER PEF - PANEL EDGE FRAMING PIL - PILASTER PL - PLATE	SEE ARCHITECTURAL DRAWINGS FOR THE FOLLOWING: A. SIZE AND LOCATION OF ALL DOOR AND WINDOW OPENINGS AND THRESI REQUIREMENTS.	HOLD
DIST — DISTANCE DS — DOUBLE STUDS DWG — DRAWING EA — EACH	PLCS — PLACES PLWD — PLYWOOD PNL — PANEL PSF — POUNDS PER SQUARE	 B. SIZE AND LOCATION OF ALL NON-BEARING PARTITIONS. C. SIZE AND LOCATION OF ROOF, FLOOR AND WALL OPENINGS. D. SIZE AND LOCATION OF DEPRESSED AREAS, CHANGES IN ELEVATION, FLAND ROOF DRAINS, SLOPES, CONCRETE CURBS, LEDGES, PADS AND IS 	
EF — EACH FACE EJT — EXPANSION JOINT EL — ELEVATION	FOOT PSI – POUNDS PER SQUARE INCH	CHAMFERS, GROOVES, INSERTS, ETC. E. DIMENSIONS NOT SHOWN ON THE STRUCTURAL DRAWINGS. F. EXTERIOR WALL SYSTEMS.	
ELEC — ELECTRICAL EMBED — EMBEDMENT EN — END NAIL EOSL — EDGE OF SLAB	RAD or R — RADIUS REF — REFERENCE REINF — REINFORCING	9. SEE ARCH, MECHANICAL, PLUMBING AND ELECTRICAL DRAWINGS FOR THE FOLLOWING: A. PIPE RUNS, SLEEVES, HANGERS, TRENCHES, WALL, ROOF AND FLOOR A. PIPE RUNS, SLEEVES, HANGERS, TRENCHES, WALL, ROOF AND FLOOR	
EQ — EQUAL EQUIP — EQUIPMENT EW — EACH WAY	REQD — REQUIRED RO — ROUGH OPENING SCHED — SCHEDULE	OPENINGS, ETC., NOT SHOWN OR NOTED. B. ELECTRICAL CONDUIT RUNS, BOXES, OUTLETS IN WALLS AND SLABS. C. ANCHORAGE AND BRACING FOR ELECTRICAL, MECHANICAL OR PLUMBING EQUIPMENT TO THE STRUCTURE.	;
EXIST — EXISTING EXP — EXPANSION EXT — EXTERIOR	Sect — Section Sht — Sheet Shtg — Sheathing	D. ANCHOR BOLTS FOR MOTOR MOUNTS. E. SIZE, WEIGHT AND LOCATION OF MACHINES AND EQUIPMENT BASES. 10. THE CONTRACT DOCUMENTS REPRESENT THE FINISHED STRUCTURE, THEY DO INDICATE THE METHOD OF CONSTRUCTION. THE CONTRACTOR SHALL PROVI	
FDN — FOUNDATION FIN — FINISH(ED) FLG — FLANGE	SIM — SIMILAR SL — SLOPE SPEC — SPECIFICATION SPCS — SPACES	ALL MEASURES NECESSARY TO PROTECT THE STRUCTURE DURING CONSTRUING SUCH MEASURES SHALL INCLUDE, BUT NOT BE LIMITED TO, BRACING, SHOR FOR LOADS DUE TO CONSTRUCTION EQUIPMENT, ETC. OBSERVATION VISITS	CTION. RING
FLR — FLOOR FO xxx — FACE OF xxx FOC — FACE OF CONCRETE FOF — FACE OF FINISH	SQ — SQUARE SSH — SHORT SLOTTED HOLE SSLT — STAINLESS STEEL	THE SITE BY THE STRUCTURAL ENGINEER SHALL NOT INCLUDE INSPECTION THE ABOVE ITEMS. 11. OPENINGS, POCKETS, ETC. SHALL NOT BE PLACED IN STRUCTURAL MEMBERS	
FOS — FACE OF STEEL FS — FAR SIDE FT — FOOT or FEET	STD - STANDARD STIF - STIFFENER STL - STEEL STRUCT - STRUCTURAL	UNLESS SPECIFICALLY DETAILED ON THE STRUCTURAL DRAWINGS. NOTIFY T STRUCTURAL ENGINEER WHEN DRAWINGS BY OTHERS SHOW OPENINGS, POC ETC., LARGER THAN 6 INCHES NOT SHOWN ON THE STRUCTURAL DRAWINGS	THE KETS,
FTG — FOOTING GA — GAGE	SYM — SYMMETRICAL	WHICH ARE LOCATED IN STRUCTURAL MEMBERS.	NTC
GALV — GALVANIZED GEN — GENERAL GR — GRADE	THK - THICK(NESS) TOC - TOP OF CONCRETE TOF - TOP OF FOOTING	12. SPECIFICATIONS, CODES, AND STANDARDS NOTED IN THE CONTRACT DOCUMES SHALL BE OF THE LATEST APPROVED ISSUE, INCLUDING SUPPLEMENTS, UNL OTHERWISE NOTED. MATERIAL SPECIFICATIONS ARE ASTM LATEST EDITION.	
GWB — GYPSUM WALLBOARD H — HIGH HD — HOLD DOWN	TOGB — TOP OF GRADE BEAM TOS — TOP OF STEEL TOSL — TOP OF SLAB TPC — TOP PLATE	13. CONTRACTOR SHALL PROVIDE TEMPORARY BRACING FOR THE STRUCTURE AND STRUCTURAL COMPONENTS UNTIL ALL FINAL CONNECTIONS HAVE BEEN COMPLETED IN ACCORDANCE WITH THE PLANS.)
HDR — HEADER HGR — HANGER	CONNECTION TYP - TYPICAL	DESIGN CRITERIA	
HORIZ — HORIZONTAL HSS — HOLLOW STRUCTURAL SECTIONS HT — HEIGHT	T&B — TOP AND BOTTOM UON — UNLESS OTHERWISE NOTED	DESIGN LOADS: ROOF DEAD LOAD PER CALCULATIONS ROOF SNOW LOAD 30 PSF	
HVAC — HEATING, VENTILATING/ AIR CONDITIONING	VERT — VERTICAL W — WIDTH	WIND DESIGN:	
	WT — WEIGHT WWF — WELDED WIRE FABRIC	BASIC WIND SPEED (3 SECOND GUST) 110 MPH EXPOSURE CATEGORY B	
	WP - WORK POINT W/ - WITH	IMPORTANCE FACTOR IW 1.0 Kzt 1.0	

SPECIAL INSPECTION

1. SPECIAL INSPECTIONS. OBSERVATIONS ARE A SUPPLEMENT TO THE CITY OF MERCER ISLAND INSPECTIONS REQUIRED BY THE INTERNATIONAL BUILDING CODE (IBC) AAR TESTING AND INSPECTION, INC (JERRY A. ANDERSON, 425-881-5812) SHALL BE

W/ – WITH

SPECIAL INSPECTIONS SHALL NOT BE REQUIRED WHEN THE WORK IS DONE ON THE PREMISES OF A FABRICATOR WITH AN AISC QUALITY CONTROL PROGRAM AND IS APPROVED BY THE BUILDING OFFICIAL TO PERFORM SUCH WORK WITHOUT SPECIAL INSPECTION.

ALL PILE DRIVING SHALL BE CONTINUOUSLY INSPECTED BY THE GEOTECHNICAL ENGINEER OF RECORD

RETAINED FOR THE FOLLOWING SPECIAL INSPECTIONS:

ALL SOILS SHALL BE PERIODICALLY INSPECTED TO VERIFY DESIGN SOIL VALUES ARE APPLICABLE.

ADHESIVE ANCHORS, EPOXY GROUT CONTINUOUS INSPECTION OF INSTALLATION OF ALL ADHESIVE

ANCHORS AND EPOXY GROUT STRUCTURAL STEEL

APPROVED FABRICATOR.

PERFORM QA AND QC INSPECTIONS LISTED IN STRUCTURAL STEEL INSPECTION SCHEDULE BELOW PER AISC 360. IF FABRICATOR HAS AN ACCREDITED QC PROGRAM IN HOUSE THE SHOP FABRICATION INSPECTIONS MAY BE CONDUCTED UNDER THAT PROGRAM. ALL FIELD WELDING SHALL BE INSPECTED BY A SPECIAL INSPECTOR. ALL CJP WELDS SHALL BE ULTRASONICALLY TESTED.

2. THE OWNER, ARCHITECT, STRUCTURAL ENGINEER, AND BUILDING OFFICIAL SHALL BE FURNISHED COPIES OF ALL TEST RESULTS AND RPORTS. REPORTS SHALL INDICATE THAT THE WORK INSPECTED WAS OR WAS NOT IN COMPLIANCE WITH APPROVED CONSTRUCTION DOCUMENTS. DISCREPANCIES SHALL BE BROUGHT TO THE IMMEDIATE ATTENTION OF THE CONTRACTOR FOR CORRECTION. IF THEY ARE NOT CORRECTED, THE DISCREPANCIES SHALL BE BROUGHT TO THE ATTENTION OF THE ENGINEER OF RECORD AND TO THE BUILDING INSPECTOR PRIOR TO THE COMPLETION OF THAT PHASE OF THE WORK. A FINAL REPORT DOCUMENTING REQUIRED SPECIAL INSPECTIONS AND TEST AND CORRECTION OF ANY DISCREPANCIES NOTED IN THE INSPECTIONS OR TESTS, SHALL BE SUBMITTED AT A POINT IN TIME AGREED UPON PRIOR TO THE START OF WORK BY THE OWNER TO THE BUILDING INSPECTOR.

3. IN ADDITION TO THE SUBMITTAL OF REPORTS, THE FOLLOWING MUST BE SUBMITTED TO THE BUILDING INSPECTOR.: CERTIFICATES OF COMPLIANCE FOR THE FABRICATION OF STRUCTURAL, LOAD BEARING OR LATERAL LOAD-RESISTING MEMBERS OR ASSEMBLIES ON THE PREMISES OF A REGISTERED AND

- RULES AND
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- l, FLOOR D ISLANDS,

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- INGS, BUT UMENTS UNLESS

DESIGN LOADS: ROOF DEAD LOAD ROOF SNOW LOAD	PER CALCULATIONS 30 PSF
WIND DESIGN:	
BASIC WIND SPEED (3 SECOND G	UST) 110 MPH
EXPOSURE CATEGORY	, B
IMPORTANCE FACTOR IW	1.0
Kzt	1.0
SEISMIC DESIGN:	
SEISMIC USE GROUP	1
Sds	0.963
SOIL CLASSIFICATION	D (ASSUMED)
IMPORTANCE FACTOR le	1.0
R	6.5

SEISMIC DESIGN FORCE SYSTEM: LIGHT FRAMED PLYWOOD SHEAR WALLS.

STRUCTURAL STEEL INSPECTION SCHEDULE	
INSPECTION TASKS PRIOR TO WELDING	
1. REVIEW MANUFACTURERS SPECIFICATIONS FOR WELDING CONSUMABLES.	l P
. MATERIAL INDENTIFATION.	Р
. WELDER IDENTIFICATION SYSTEM	0
. FIT UP OF FILLET WELDS (DIMENSIONS, CLEANLINESS, TACKING)	0
. CHECK WELDING EQUIPMENT	0
INSPECTION TASKS DURING WELDING	
. REVIEW WELDERS QUALIFICATIONS	0
. CONTROL AND HANDLING OF WELDING CONSUMABLES (PACKAGING, EXP CONTROL)	0
. ENVIRONMENTAL CONDITIONS (WIND SPEED WITHIN LIMITS, PRECIP AND TEMP)	0
WELDING PROCEDURES FOLLOWED (WELDING EQUIPMENT SETTINGS, TRAVEL	
PEED, WELDING MATERIALS, SHIELD GAS TYPE AND FLOW RATE, PREHEAT, INTERPASS	l 0
MP MAINTAINED, PROPER POSITION)	
WELDING TECHNIQUES (INTERPASS AND FINAL CLEANING, EACH PASS MEETS	
ROFILE LIMITS, EA PASS MEETS QUALITY REQUIREMENTS)	0
INSPECTION TASKS AFTER WELDING	
. WELDS CLEANED	0
. SIZE LENGTH AND LOCATION OF WELDS	P
5. WELDS MEET VISUAL ACCEPTANCE CRITERIA (CRACK PROHIBITION, WELD BASE METAL	_
USION, CRATER CROSS SECTION, WELD PROFILES, WELD SIZE, UNDERCUT, POROSITY)	P
. k-area	P
5. ARC STRIKES.	P
6. REPAIR ACTIVITIES	P
7. DOCUMENT ACCEPTANCE OR REJECTION OF MEMBER OR WELDED JOINT	P
O = OBSERVE PERIODICALLY AND ON A RANDOM BASIS	
P = PERFORM OBSERVATION CONTINUOUSLY FOR EA WELDED JT OR MEMBER	

FOUNDATIONS

FOUNDATION DESIGN BASED UPON GEOTECHNICAL REPORT PREPARED BY GEOTECHNICAL CONSULTANTS, INC DATED 12/11/2020.

SOILS CRITERIA

RETAINING WALLS		
EQUIVALENT FLUID PRESSURE	UNRESTRAINED LEVEL BACKFILL SEISMIC RESTRAINED LEVEL BACKFILL	35 PCF 8H 10H SURCH
ALLOWABLE PASSIVE PRESSURE COEF OF FRICTION	LEVEL UNDIST CUT	300 PCF 0.4
BEARING SURFACES		
ALLOWABLE BEARING		3000 PSF
TEMPORARY SHORING TEMPORARY SHORING	ACTIVE PRESSURE ULT PASS PRESS START	35 PCF 400 PCF
PIPE PILE CRITERIA		
INSIDE PIPE	FINAL DRIV RATE	ALL COMP

- DIAMETER 1100# HAMMER 2000# HAMMER 3000# HAMMER CAPACITY 10 SEC/IN 4 SEC/IN N/A 20 KIPS 20 SEC/IN 10 SEC/IN 6 SEC/IN 30 KIPS
- ALL FOUNDATIONS SHALL BE FOUNDED A MINIMUM OF 18" BELOW LOWEST ADJACENT FINAL FINISH FLOOR OR GRADE. ALL BEARING SURFACES SHALL BE INSPECTED BY GEOTECH OF RECORD
- PRIOR TO PLACING CONCRETE. 3. ALL PIPE PILE INSTALLATION SHALL BE CONTINUOUSLY INSPECTED BY A REPRESENTATIVE OF THE GEOTECH OF RECORD.

CONCRETE

- 1. ALL CONCRETE CONSTRUCTION SHALL CONFORM TO THE 'BUILDING CODE REQUIREMENTS FOR REINFORCED CONCRETE' ACI 318 AND ACI 301, WITH MODIFICATIONS AS NOTED IN THE CONTRACT DOCUMENTS.
- 2. PORTLAND CEMENT SHALL CONFORM TO ASTM C-150 TYPE I OR TYPE II.
- 3. COARSE AND FINE AGGREGATE FOR NORMAL WEIGHT CONCRETE SHALL CONFORM
- 4. AGGREGATE FOR LIGHTWEIGHT CONCRETE SHALL CONFORM TO ASTM C-330 AND THE PROJECT SPECIFICATIONS.
- 5. WATER SHALL BE CLEAR AND SHALL CONFORM TO ASTM C-94.
- 6. CONCRETE MIXING OPERATION SHALL CONFORM TO ASTM C-94.
- 7. ADD TO ALL CONCRETE EXPOSED TO WEATHER MICROAIR OR MBVR AIR ENTRAINING AGENT TO ATTAIN 5 PERCENT +/- 1 PERCENT ENTRAINED AIR, BY VOLUME, CONFORMING TO ASTM C-260. ALL REFERENCE DATA USED FOR PAST PERFORMANCE DESIGN SHALL HAVE CONTAINED THE SAME ADMIXTURE BRAND AS THAT USED IN THE MIX SUBMITTED.
- 8. CONCRETE STRENGTHS SHALL BE VERIFIED BY PREVIOUS 28-DAY CYLINDER TESTS, UNLESS OTHERWISE APPROVED. CONCRETE SHALL BE AS FOLLOWS:

ELEMENT	DES STRENGTH USED IN CALCS	MIX DESIGN STRENGTH PSI	CONCRETE TYPE
FOOTINGS	2500	4000	5 1/2 SACK W/C<.45
WALLS	2500	4000	5 1/2 SACK W/C<.45
SLAB ON GRADE	2500	4000	5 1/2 SACK W/C<.4

9. CONTRACTOR MAY USE AN ADMIXTURE SYSTEM TO PRODUCE FLOWABLE CONCRETE. MAXIMUM SLUMP SHALL NOT EXCEED 10 INCHES MEASURED AT THE PUMP. THE WATER/CEMENTIOUS MATERIAL RATIO OF THE APPROVED MIXES SHALL BE MAINTAINED OR LOWERED WHEN FLOWABLE CONCRETE IS USED. REPRESENTATIVE OF THE ADMIXTURE SYSTEM SHALL ASSIST IN DETERMINING PROPORTIONS FOR FLOWABLE CONCRETE AND SHALL BE REVIEWED BY THE STRUCTURAL ENGINEER AND ARCHITECT PRIOR TO EMPLOYING THIS PROCEDURE.

10. THE FOLLOWING MINIMUM CONCRETE COVER SHALL BE PROVIDED FOR

	REINFORCEMENT PLACED IN CAST-IN-PLACE CONCRETE:	CONCRETE COVER (MI
A.	CONCRETE CAST AGAINST AND PERMANENTLY EXPOSED TO EARTH:	3"
В.	CONCRETE EXPOSED TO EARTH OR WEATHER: #6 THROUGH #18 BARS #5 BAR, W31 OR D31 WIRE, AND SMALLER	2" 1 1/2"
C.	CONCRETE NOT EXPOSED TO WEATHER OR IN CONTACT WITH GROUND: SLABS, WALLS, JOISTS: #14 AND #18 BARS #11 BARS AND SMALLER BEAMS, COLUMNS:	1 1/2" 3/4"
	PRIMARY REINFORCEMENT, TIES, STIRRUPS, SPIRALS SHELLS, FOLDED PLATE MEMBERS:	1 1/2"
	#6 BAR AND LARGER #5 BAR, W31 OR D31 WIRE, AND SMALLER	3/4" 1/2"
	W	· / -

- 11. BASE PLATE GROUT SHALL BE NON-SHRINK TYPE WITH F'c=7000 PSI, GRADE B, CONFORMING TO ASTM C-1107.
- 12. PLACEMENT OF CONCRETE SHALL CONFORM TO ACI 304 AND THE CONTRACT DOCUMENTS. SANDBLAST ALL CONCRETE SURFACES AGAINST WHICH CONCRETE
- 13. PROJECTING CORNERS OF BEAMS, WALLS, COLUMNS, ETC., SHALL BE FORMED WITH A 3/4 INCH CHAMFER, UNLESS OTHERWISE NOTED ON THE ARCHITECTURAL DRAWINGS.
- 14. ALL REINFORCING BARS, ANCHOR BOLTS AND OTHER CONCRETE INSERTS SHALL BE WELL SECURED IN POSITION PRIOR TO PLACING CONCRETE.
- 15. PROVIDE SLEEVES FOR PLUMBING AND ELECTRICAL OPENINGS IN CONCRETE BEFORE PLACING. REINFORCING SHALL NOT BE CUT. CORING OF CONCRETE IS NOT PERMITTED EXCEPT AS INDICATED.
- 16. CONDUIT OR PIPE SIZE (O.D.) SHALL NOT EXCEED ONE THIRD OF THE SLAB THICKNESS AND SHALL BE PLACED BETWEEN THE TOP AND BOTTOM REINFORCING, UNLESS SPECIFICALLY DETAILED OTHERWISE. CONCENTRATIONS OF CONDUIT OR PIPES SHALL BE AVOIDED EXCEPT WHERE DETAILED OPENINGS ARE PROVIDED.
- 17. CURING COMPOUNDS USED ON CONCRETE TO RECEIVE A FINISH SHALL BE APPROVED BY THE FINISH APPLICATOR BEFORE USE.

REINFORCING STEEL

- 1. REINFORCING STEEL SHALL BE DETAILED, INCLUDING HOOKS AND BENDS, AND PLACED IN ACCORDANCE WITH ACI 315 AND ACI 318.
- 2. REINFORCING STEEL SHALL CONFORM TO ASTM A-615 OR A-706, GRADE 60.
- 3. WELDED WIRE FABRIC SHALL CONFORM TO ASTM A-185.
- 4. ALL REINFORCING BAR BENDS SHALL BE MADE COLD.
- 6. DOWELS BETWEEN FOOTINGS AND WALLS OR COLUMNS SHALL BE THE SAME GRADE, SIZE AND SPACING AS THE VERTICAL REINFORCING, RESPECTIVELY, ULESS OTHERWISE NOTED.

5. REINFORCING SPLICES SHALL BE MADE AS INDICATED ON THE DRAWINGS.

- 7. PROVIDE #4 x 2'-0" DIAGONAL BAR AT ALL REENTRANT CORNERS OF CONCRETE SLABS ON GRADE.
- 8. NO BARS PARTIALLY EMBEDDED IN HARDENED CONCRETE SHALL BE FIELD BENT UNLESS SPECIFICALLY SO DETAILED AND REVIEWED BY THE STRUCTURAL ENGINEER.
- 9. WELDING OF REINFORCEMENT SHALL BE WITH LOW HYDROGEN ELECTRODES IN CONFORMANCE WITH ACI 318-83 AND THE RECOMMENDATIONS OF THE AMERICAN WELDING SOCIETY, AWS D1.4 AND WITH THE REVIEW OF THE
- STRUCTURAL ENGINEER. 10. PROVIDE SHOP DRAWINGS FOR REINFORCING FOR CONCRETE BEAMS AND GRADE BEAMS.

- EXPANSION SHALL BE ZINC PLATED IN ACCORDANCE WITH ASTM B633, AND CONFORM WITH FS FF-S-325, GROUP II, TYPE 4, CLASS 1.
- 2. SLEEVE ANCHORS SHALL BE ZINC PLATED IN ACCORDANCE WITH ASTM B633, AND CONFORM WITH FS FF-S-325, GROUP II, TYPE 3, CLASS 3.
- 3. FLUSH SHELL ANCHORS SHALL BE ZINC PLATED IN ACCORDANCE WITH ASTM B633, AND CONFORM WITH FS-FF-S-325, GROUP VIII, TYPE 1.
- 4. ADHESIVE ANCHORS SHALL CONSIST OF ALL-THREAD ANCHOR ROD, NUT. WASHER, AND EPOXY INJECTION GEL OR ADHESIVE CAPSULE SYSTEM. ANCHOR RODS SHALL BE MANUFACTURED FROM A-36 MATERIAL, ZINC PLATED IN ACCORDANCE WITH ASTM B633.
- 5. ALL RELATED PRODUCTS, MATERIALS, AND INSTALLATION SHALL BE IN ACCORDANCE WITH THE MANUFACTURER'S RECOMMENDATIONS.
- 6. NOTATIONS ON DRAWINGS RELATING TO EXPANSION, SLEEVE, FLUSH, OR ADHESIVE ANCHORS AND OTHER CONNECTING DEVICES REFER TO CONNECTORS MANUFACTURED BY POWERS FASTENING, INC. EQUIVALENT DEVICES BY OTHER MANUFACTURERS MAY BE SUBSTITUTED PROVIDED THAT THEY HAVE ICBO APPROVAL FOR EQUAL OR GREATER LOAD CAPACITIES AND ARE REVIEWED BY THE STRUCTURAL ENGINEER.

STRUCTURAL STEEL, MISC. METAL

STRUCTURAL STEEL DETAILING, FABRICATION AND ERECTION SHALL BE BASED ON THE LATEST EDITION AND SUPPLEMENTS OF THE AISC "SPECIFICATION FOR STRUCTURAL STEEL FOR BUILDINGS - ALLOWABLE STRESS DESIGN AND PLASTIC DESIGN". STRUCTURAL STEEL SHALL CONFORM TO THE FOLLOWING REQUIREMENTS.

TYPE OF MEMBER ASTM SPECIFICATION

PLATES, SHAPES, ANGLES, AND W SHAPES	A36 (UON)	36
HOLLOW STRUCTURAL SECTIONS (ROUND, SQUARE OR RECTANGLE)	A500 (GRADE B)	46 K

ANCHOR RODS (EMBEDDED IN CONCRETE) CONNECTION BOLTS (STEEL TO STEEL) CONNECTION BOLTS (STEEL TO WOOD) A307 (UON)

- 2. WELDED HEADED STUDS SHALL BE NELSON GRANULAR FLUX-FILLED STUDS OR AN APPROVED EQUAL.
- 3. THE STRUCTURAL STEEL FABRICATOR SHALL FURNISH SHOP DRAWINGS FOR REVIEW BEFORE FABRICATION.
- 4. ALL WELDS SHALL BE PREQUALIFIED IN CONFORMANCE WITH AISC AND AWS STANDARDS AND SHALL BE PERFORMED BY WELDERS WABO CERTIFIED. USE E70XX ELECTRODES.
- WELD LENGTHS CALLED FOR ON THE PLANS ARE THE NET EFFECTIVE LENGTH REQUIRED. WELD SIZE SHALL BE AISC MINIMUM, UNLESS OTHERWISE NOTED.

- FRAMING LUMBER SHALL BE GRADED AND MARKED IN CONFORMANCE WITH WCLB STANDARD GRADING AND DRESSING RULES FOR WEST COAST LUMBER NO. 16, LATEST EDITION. UNLESS OTHERWISE NOTED ON THE DRAWINGS, LUMBER GRADES SHALL BE AS FOLLOWS:
- A. JOISTS: 2 INCH AND 3 INCH THICKNESS, HEM FIR NO. 1.
- B. BEAMS AND STRINGERS: DOUGLAS FIR NO. 2.
- C. POST AND TIMBERS: DOUGLAS FIR NO. 12
- D. PLATES AND MISCELLANEOUS LIGHT FRAMING: HEM FIR STANDARD.
- E. STUDS: HEM FIR STUD.
- 2. MINIMUM NAILING REQUIREMENTS:

UNLESS OTHERWISE NOTED, MINIMUM NAILING SHALL CONFORM TO IBC-TABLE 2304.9.1 AND AS FOLLOWS:

- A. JOISTS OR RAFTERS TO SIDES OF STUDS 8 INCH OR LESS 3-16D B. FOR EACH ADDITIONAL 4 INCH IN DEPTH OF JOISTS
- C. JOISTS OR RAFTERS AT ALL BEARINGS—TOENAILS EACH SIDE 2—10D D. STUDS TO BEARING - TOENAILS EACH SIDE
- E. BLOCKING BETWEEN JOISTS OR RAFTERS: TO JOIST OR RAFTERS-TOENAILS EACH SIDE EACH END TO JOIST OR RAFTER BEARINGS-TOENAILS EACH SIDE F. CROSS-BRIDGING BETWEEN JOISTS OR RAFTERS TOENAILS
- EACH END G. BLOCKING BETWEEN STUDS - TOENAILS EACH END 2-10D
- H. DOUBLE TOP PLATES LOWER PLATE TO TOP OF STUD 2-16D J. UPPER TO LOWER PLATE - STAGGERED 16D @ 16" OC K. WALL TOP PLATE SPLICE -
- L. MULTIPLE JOISTS STAGGERED M. MULTIPLE JOISTS - STAGGER FOR WIDTHS MORE THAN 4 INCHES
- 16D @ 12"OC 16D @ 12" OC

2-10D

2-10D

- 3. INDIVIDUAL MEMBERS OF BUILT-UP POSTS AND BEAMS SHALL EACH BE ATTACHED WITH 16D SPIKES AT 12" OC STAGGERED, MIN.
- 4. ALL NAILS SHALL BE COMMON WIRE NAILS. WHENEVER POSSIBLE, NAILS NAILS FOR 1 INCH THICK MATERIAL, 16D NAILS FOR 2 INCH THICK MATERIAL, AND 40D NAILS FOR 3 INCH THICK MATERIAL. ALL SIZES AS CALLED ABOVE.
- 5. NOTATIONS ON DRAWINGS RELATING TO FRAMING CLIPS, JOIST HANGERS,
- 6. AT SAWN TIMBER JOISTS WITH THICKNESS-TO-DEPTH RATION OF 1:6 AND GREATER, PROVIDE CROSS-BRIDGING AT 8'-0" OC.
- 7. ALL WOOD FRAMING DETAILS NOT SHOWN OTHERWISE SHALL BE
- 8. ALL BEARING AND EXTERIOR STUD WALLS SHALL BE 2x6 @ 16" OC UNLESS OTHERWISE NOTED.
- 9. PROVIDE CONTINUOUS SOLID BLOCKING AT MID-HEIGHTS AND AT INTERVALS NOT TO EXCEED 8'-0" OF ALL STUD-BEARING WALLS OVER 8'-0" IN HEIGHT.
- 10. ALL CANTS AND CRICKETS SHALL BE PLACED OVER BASIC ROOF SHEATHING. SEE ARCHITECTURAL DRAWINGS FOR DETAILS AND LOCATIONS.
- 11. ALL WOOD STUD WALL SILL PLATES SHALL BE ATTACHED TO AT 48" OC, UNLESS OTHERWISE NOTED.
- 12. ALL WOOD STUD WALLS SHALL HAVE LOWER WOOD PLATE ATTACHED TO WOOD FRAMING BELOW WITH 16D NAILS AT 6" OC STAGGERED
- 13. FASTEN ALL POSTS TO CONCRETE WITH "CB" COLUMN BASE OR EQUAL.
- OR MASONRY SHALL BE PRESSURE TREATED WITH AN APPROVED PRESERVATIVE IN ACCORDANCE WITH AWPS-FDN, AND BEAR THAT QUALITY MARK.
- 15. PROVIDE 3x3x.229" PLATE WASHERS UNDER ALL ANCHOR BOLT NUTS IN CONTACT WITH WOOD.
- 16. ATTACH TIMBER JOISTS TO FLUSH HEADERS AND BEAMS WITH "U" SERIES METAL JOIST HANGERS TO SUIT THE JOIST SIZE.
- 17. ALL PLYWOOD SHALL BE DOUGLAS FIR, STRUCTURAL II AND SHALL CONFORM TO APA C-D INTERIOR GRADE WITH EXTERIOR GLUE AND WITH PRODUCT STANDARD PS1. WOOD-BASED STRUCTURAL-USE PANELS SHALL CONFORM WITH PRODUCT STANDARD PS2.
- 18. PANEL TYPE AND NAILING, USE UNLESS OTHERWISE NOTED:
 - WALLS: 15/32" APA RATED PANELS
- 19. MACHINE APPLIED NAILING IS SUBJECT TO A SATISFACTORY REMOVED AND REPLACED. THE APPROVAL IS SUBJECT TO CONTINUED SATISFACTORY PERFORMANCE. MACHINE APPLIED NAILING ONLY ON PLYWOOD GREATER THAN 5/16".
- 20. ALL FASTENERS, INCLUDING NUTS AND WASHERS, IN CONTACT WITH PRESERVATIVE TREATED LUMBER OR EXPOSED TO WEATHER SHALL BE HOT DIPPED GALVANIZED OR STAINLESS STEEL.
- 21. CONNECTORS THAT ARE USED IN EXTERIOR APPLICATIONS AND N CONTACT WITH PRESERVATIVE TREATED WOOD SHALL HAVE CAOTING TYPES AND WEIGHTS IN ACCORDANCE WITH THE TRATED WOOD OR CONNECTOR MANUFACTURER'S RECOMMENDATIONS. IN THE ABSENCE OF SUCH RECOMMENDATIONS, A MINIMUM OF ASTM A653, TYPE G185 ZINC COTING GALVANIZED STEEL OR EQUIVALENT SHALL BE USED.


- DRIVEN PERPENDICULAR TO THE GRAIN SHALL BE USED. THERE SHALL BE A MINIMUM OF 2 NAILS AT ALL WOOD CONTACTS AND JOINTS USING 8D CONTINUOUS CONTACTS PROVIDE MINIMUM NAILS AT 12" OC WITH NAIL
- AND OTHER CONNECTING DEVICES REFER TO CATALOG NUMBERS OF STRONG-TIE CONNECTORS MANUFACTURED BY THE SIMPSON COMPANY. EQUIVALENT DEVICES BY OTHER MANUFACTURERS MAY BE SUBSTITUTED PROVIDED THAT THEY HAVE ICBO APPROVAL FOR EQUAL OR GREATER LOAD CAPACITIES AND ARE REVIEWED BY THE STRUCTURAL ENGINEER.
- AND SOLID BLOCKING AT BEARING POINTS.
- CONSTRUCTED TO THE MINIMUM STANDARDS OF THE GOVERNING CODE.

- CONCRETE OR MASONRY WITH 5/8 INCH DIAMETER ANCHOR BOLTS
- UNLESS SHOWN OTHERWISE.
- 14. ALL WOOD PLATES AND BLOCKING IN DIRECT CONTACT WITH CONCRETE

- - FLOOR: 11/8" T&G APA RATED PANELS 10d @ 4" OC AT ALL SUPPORTED EDGES. 10d @ 12" OC AT INTERMEDIATE BEARING POINTS.
 - ROOF: %" PW APA RATED PANELS 10d @ 4" OC AT SUPPORTED SHEET EDGES. 10d @ 12" OC AT INTERMEDIATE BEARING POINTS.
- 10d @ 6" OC AT SHEET EDGES UNLESS NOTED OTHERWISE ON SHEAR WALL SCHEDULE. 10d @ 12" OC AT INTERMEDIATE BEARING POINTS.
- PLYWOOD AND WOOD-BASED STRUCTURAL-USE PANELS USED FOR WALL SHEATHING SHALL HAVE SOLID BLOCKING AT ALL EDGES.
- DEMONSTRATION AND THE APPROVAL OF THE CHECKING AGENCY AND THE ARCHITECT. NAIL HEADS SHALL NOT PENETRATE THE OUTER PLY MORE THAN WOULD BE NORMAL FOR A HAND HAMMER. EDGE DISTANCES SHALL BE MAINTAINED. SHINERS SHALL BE

GARY GILL, SE 1125 NE 152nd STREET SHORELINE, WA 98155 PH: 206-992-2728 GILL26608@YAHOO.COM

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PROJECT:

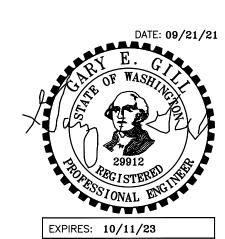BIRD McDONALD RESIDENCE 4304 E MERCER WAY MERCER ISLAND, WA 98040

CLIENT:

PAUL McDONALD & CARLY BIRD-VOGEL 4304 E MERCER WAY MERCER ISLAND, WA 98040

ISSUE:

PERMIT SET

09/21/2021


DATE:

21 SEPT 2021

SHEET TITLE: GENERAL NOTES &

ABBREVIATIONS


SHEET:

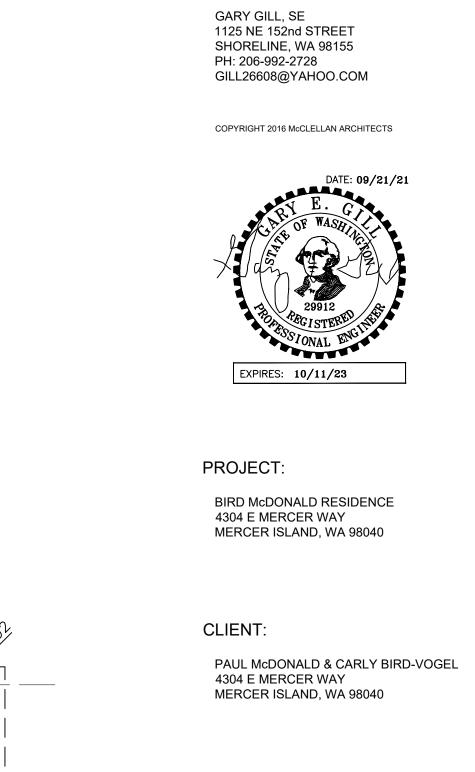

ISSUE:

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09/21/2021

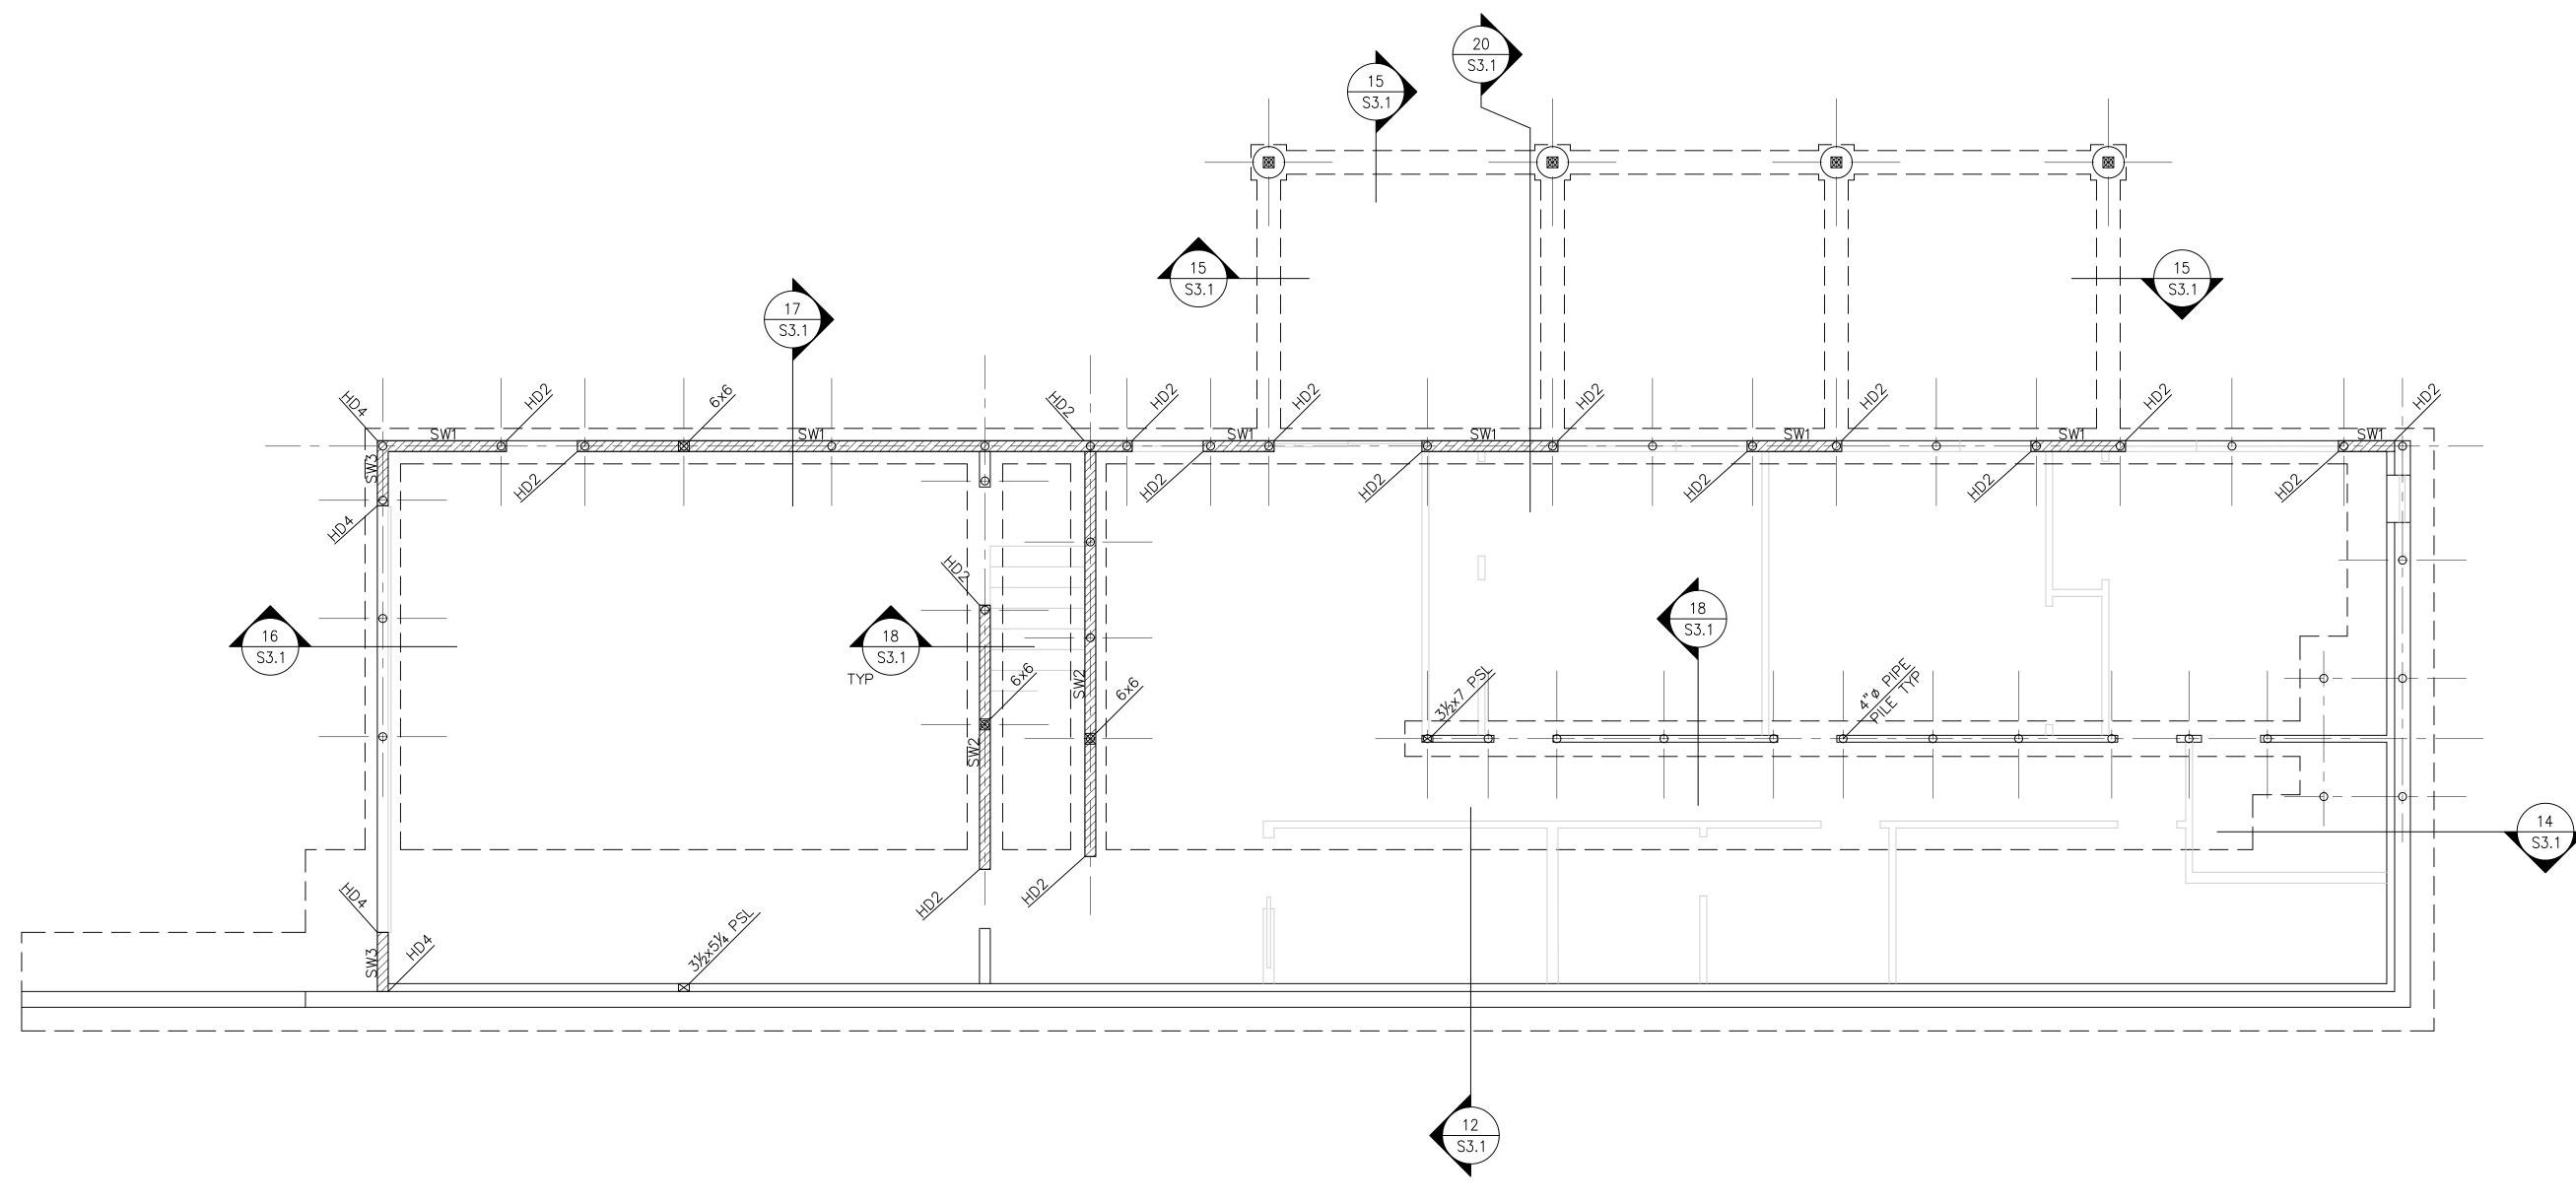

1 BASEMENT PLAN

SCALE: 1/4" = 1'-0"

DATE:

21 SEPT 2021


SHEET TITLE:
BASEMENT PLAN

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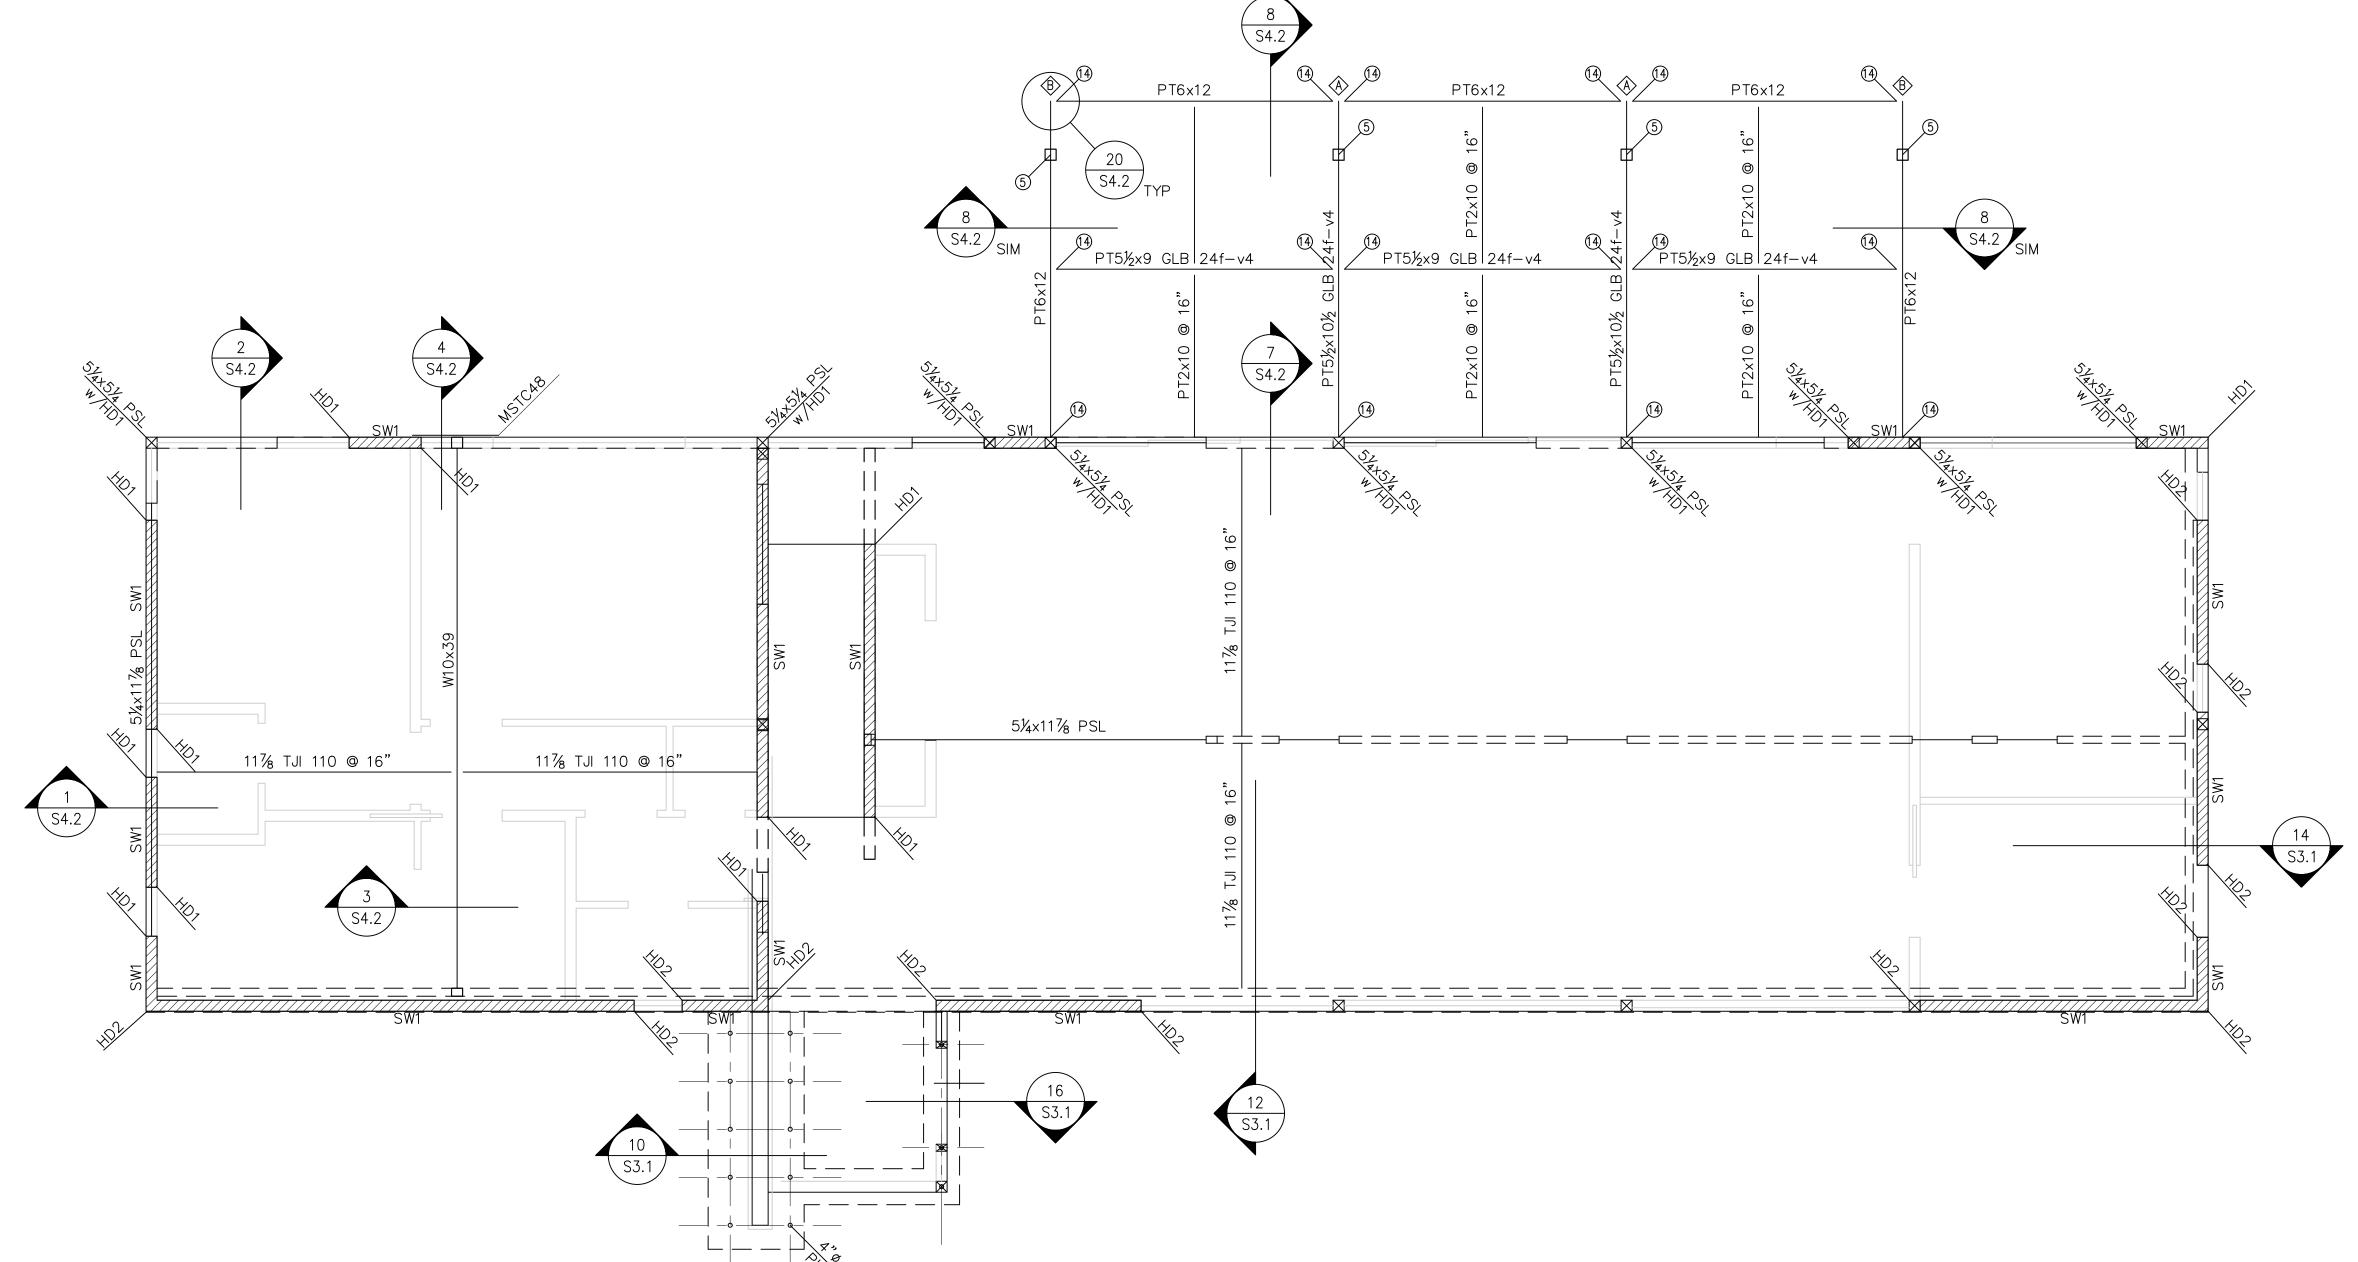
CLIENT:

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ISSUE:

PERMIT SET

09/21/2021

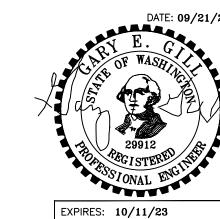

 MARK
 HANGER

 1
 HUCQ410

 2
 HUCQ610

 3
 HUCQ412

 4
 HUCQ612

 5
 AC6 MAX (HDG ❷ DECK)

 6
 HUCQ1.81/11-SDS

 7
 HUC416 MAX

 8
 HUC610 MAX

 9
 HUC68 MAX w/A35 TOP

 10
 A35 TOP & BOT

 11
 HUC414-2 MAX

 12
 LPC6Z

 13
 HUC68 MAX

 14
 HUCQ610 HDG

HANGER SCHEDULE

NOTES: 1. WHEN CALLOUT HAS AN ASTERISK, HANGER IS INVERTED.


1st FLOOR FRAMING PLAN SCALE: 1/4" = 1'-0"

DATE:

21 SEPT 2021

SHEET TITLE:
1ST FLR FRAMING

& GAR FLR PLAN

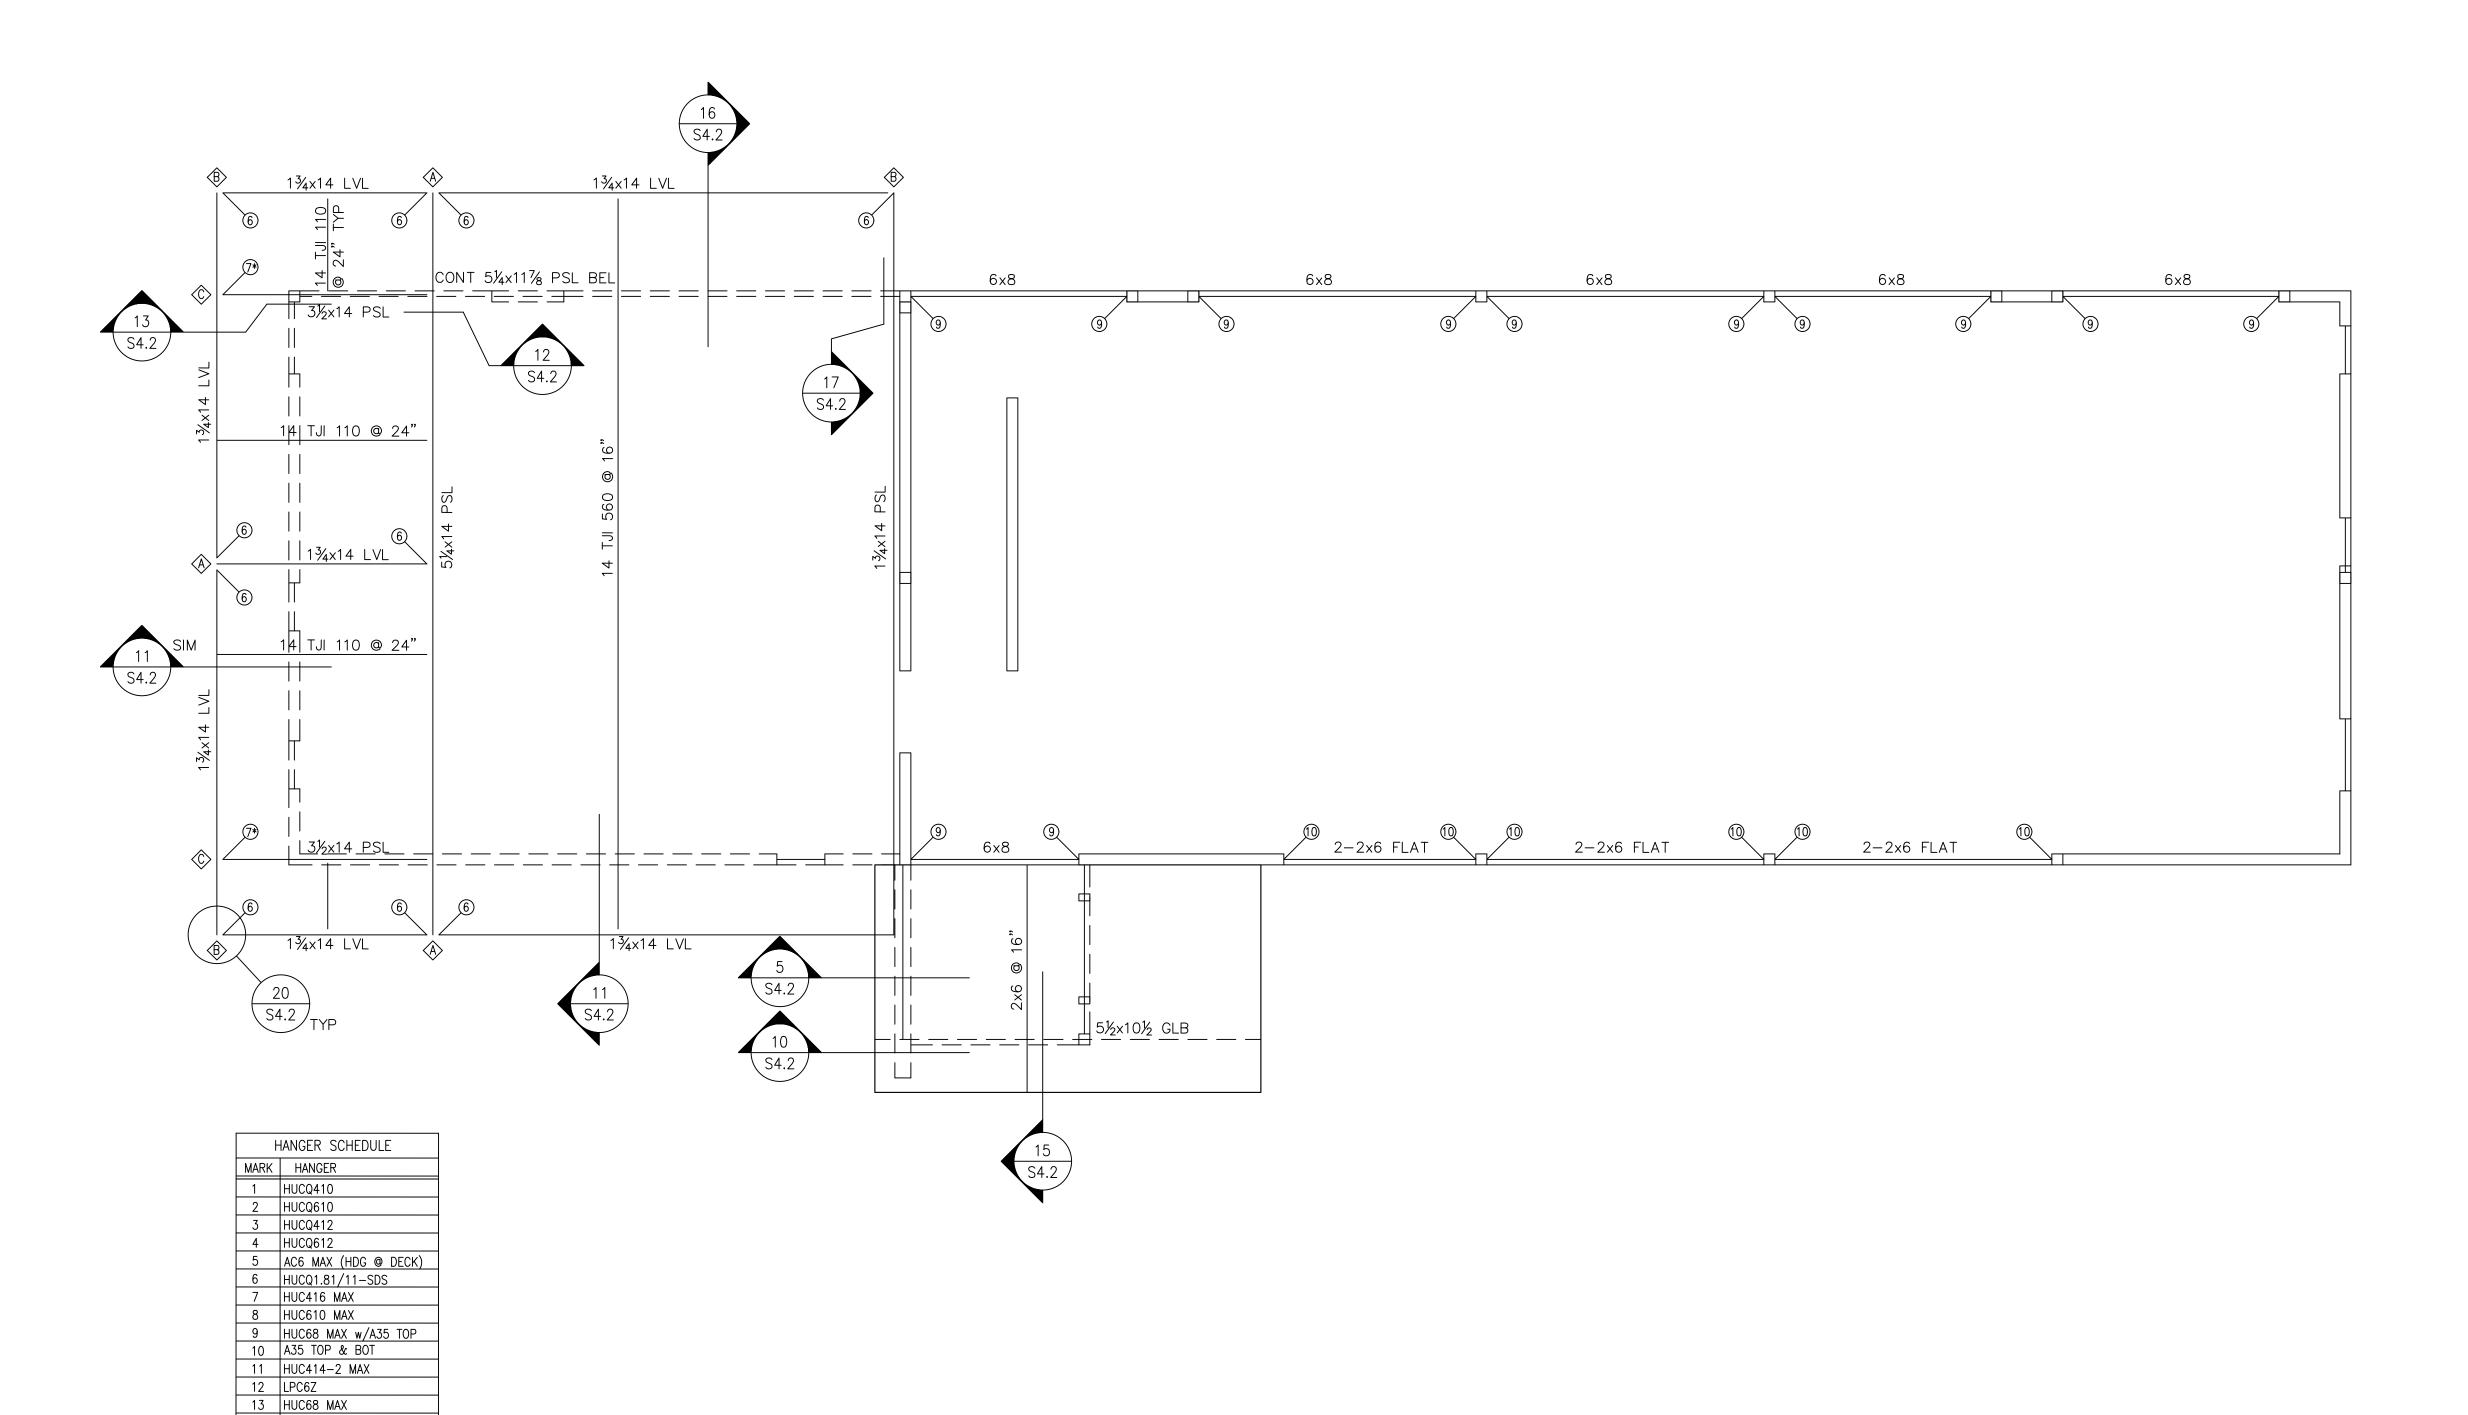


NOTES: 1. WHEN CALLOUT HAS AN ASTERISK, HANGER IS INVERTED.

14 HUCQ610 HDG



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09/21/2021

DATE:

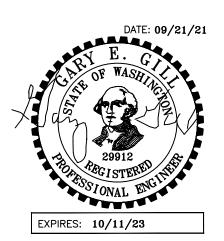
21 SEPT 2021

SHEET TITLE:


LOWER ROOF

FRAMING PLAN

EI:

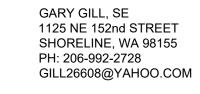

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PROJECT:

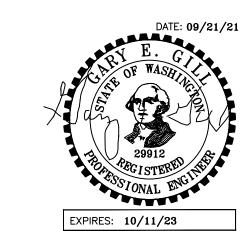BIRD McDONALD RESIDENCE 4304 E MERCER WAY MERCER ISLAND, WA 98040


CLIENT:

PAUL McDONALD & CARLY BIRD-VOGEL 4304 E MERCER WAY MERCER ISLAND, WA 98040

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PERMIT SET

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 MARK
 HANGER

 1
 HUCQ410

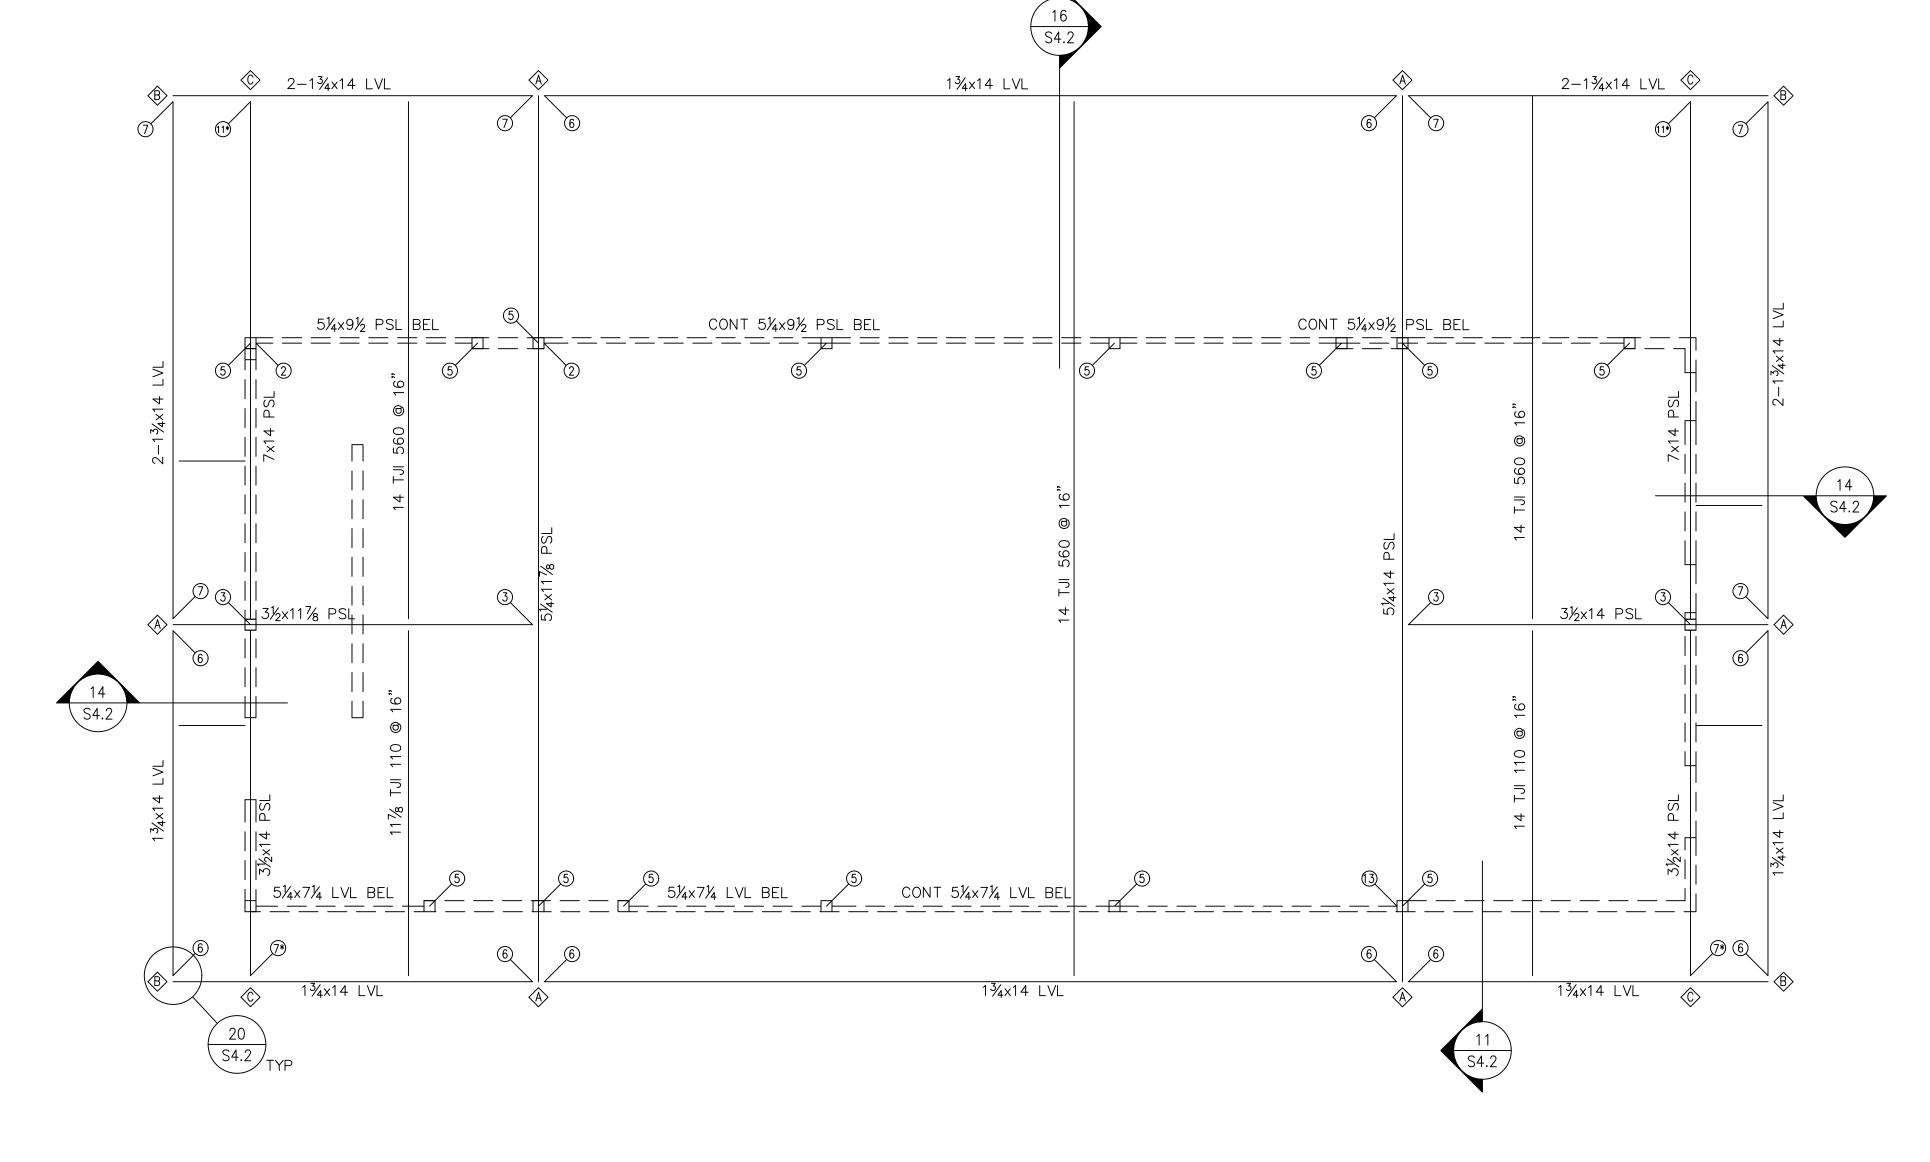 2
 HUCQ610

 3
 HUCQ412

 4
 HUCQ612

 5
 AC6 MAX (HDG @ DECK)

 6
 HUCQ1.81/11-SDS

 7
 HUC416 MAX

 8
 HUC610 MAX

 9
 HUC68 MAX w/A35 TOP

 10
 A35 TOP & BOT

 11
 HUC414-2 MAX

 12
 LPC6Z

 13
 HUC68 MAX

 14
 HUCQ610 HDG

HANGER SCHEDULE

NOTES: 1. WHEN CALLOUT HAS AN ASTERISK, HANGER IS INVERTED.





DATE: 21 SEPT 2021


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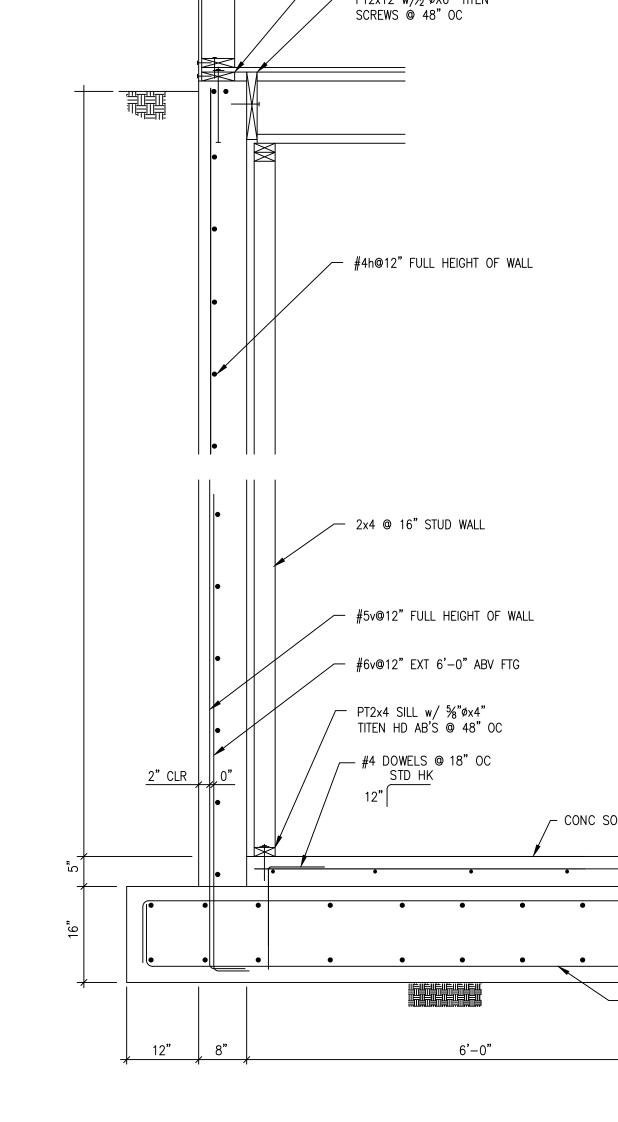
FRAMING PLAN


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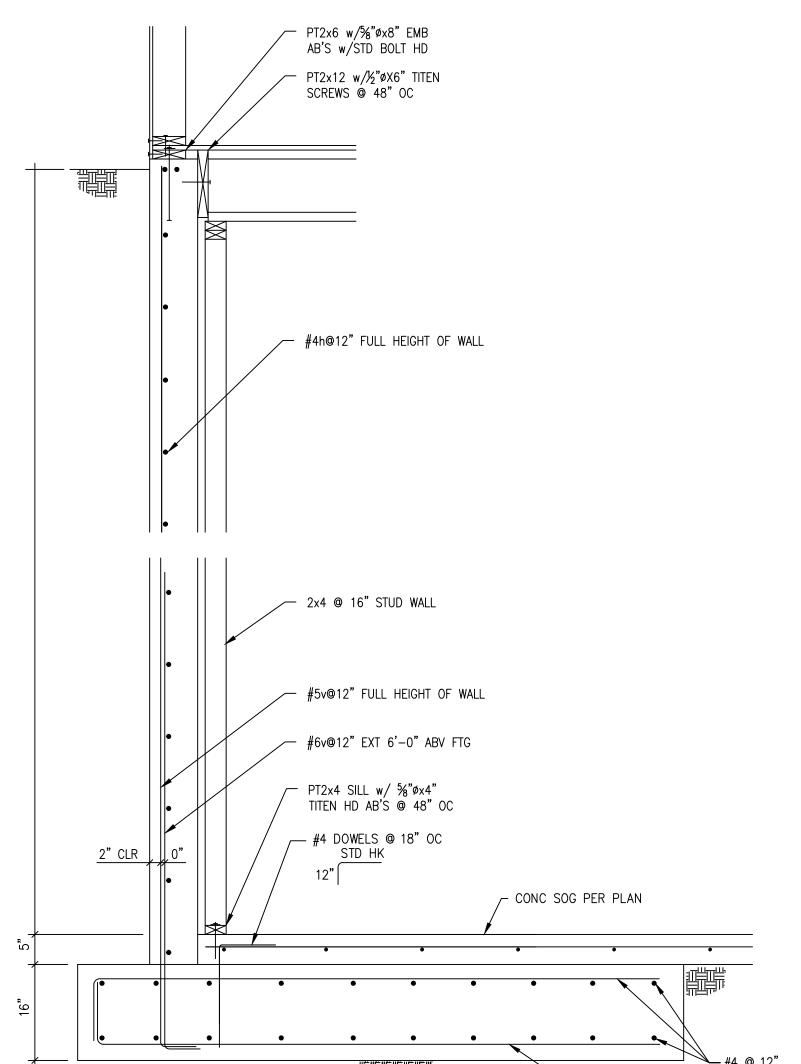





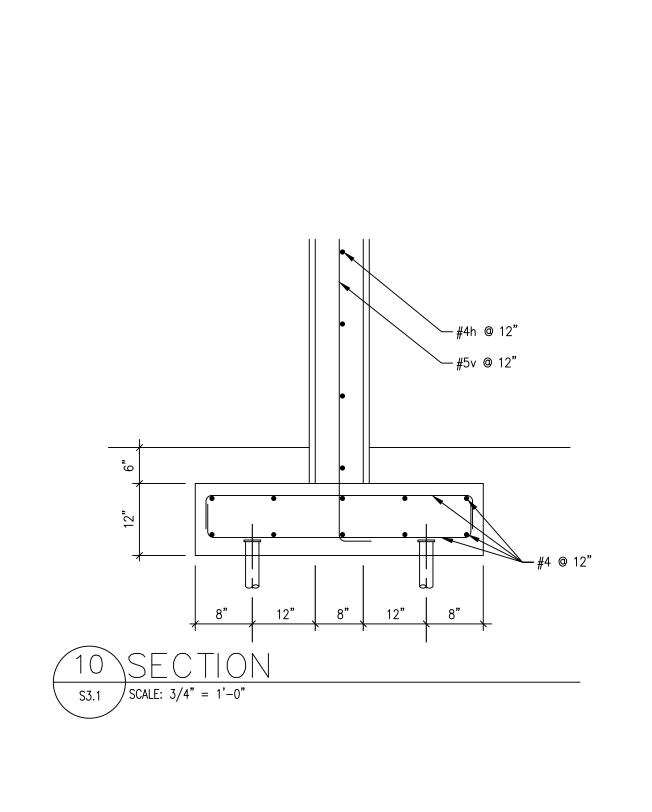

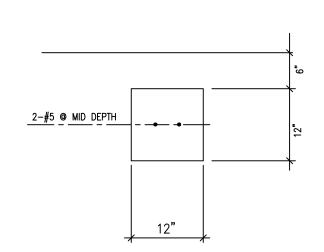

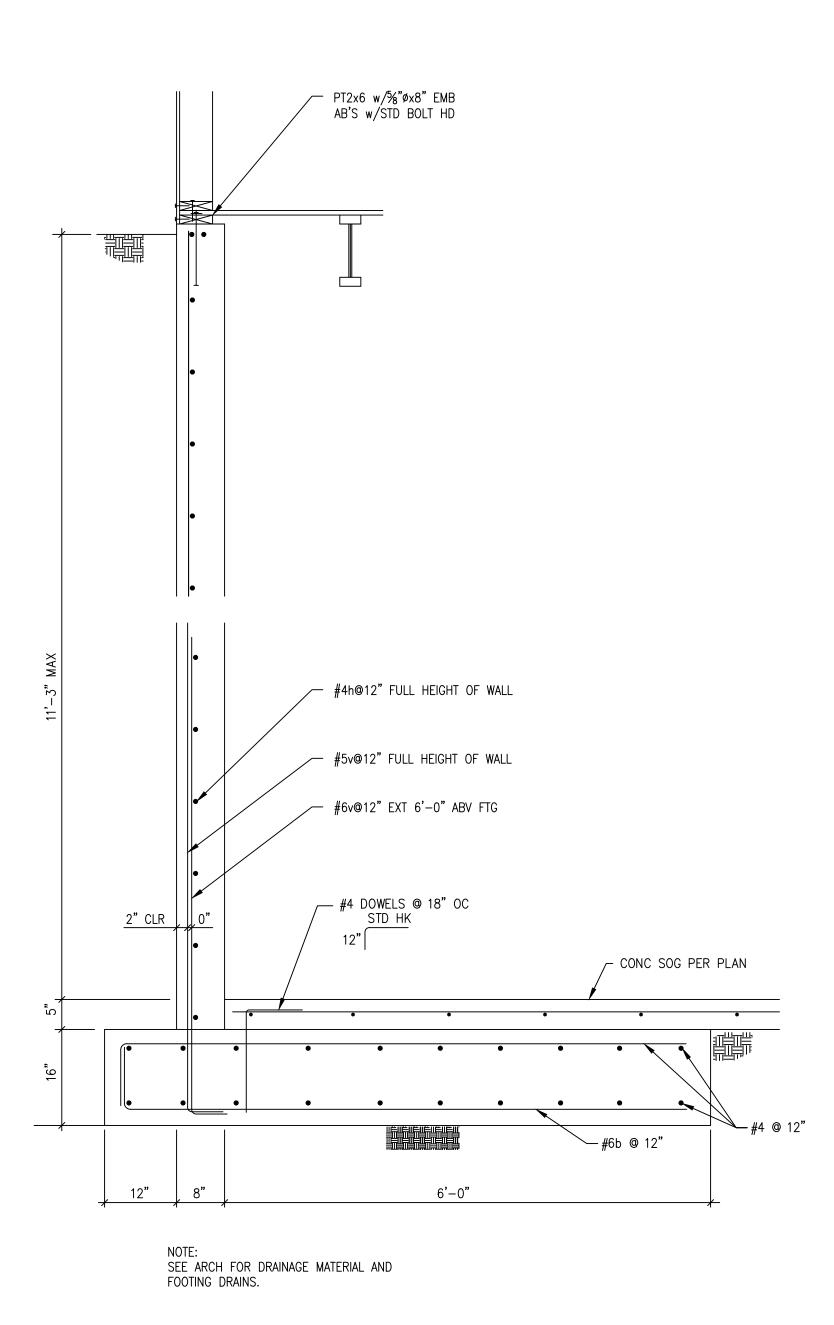


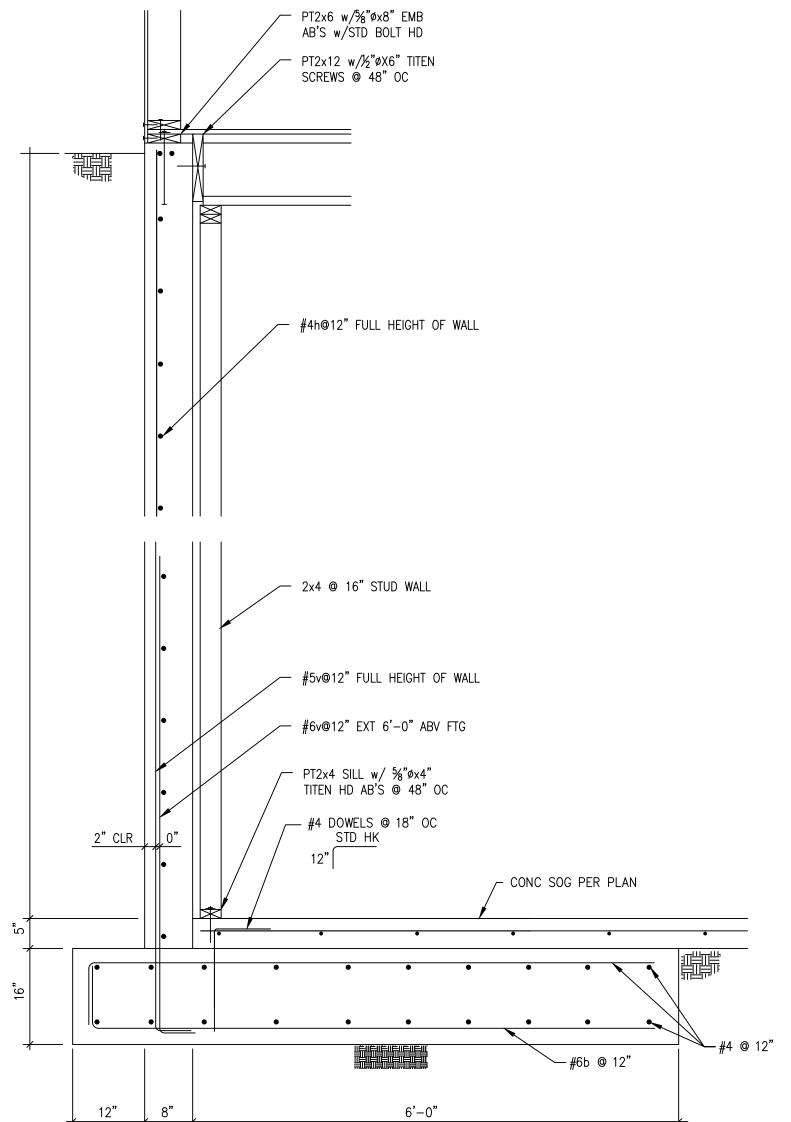


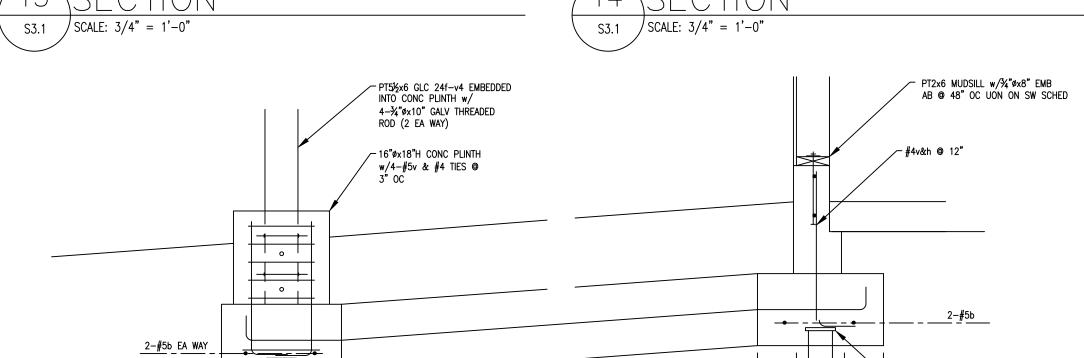

∽ PIN PILE PER PLAN w/3"EMB

18" SQ

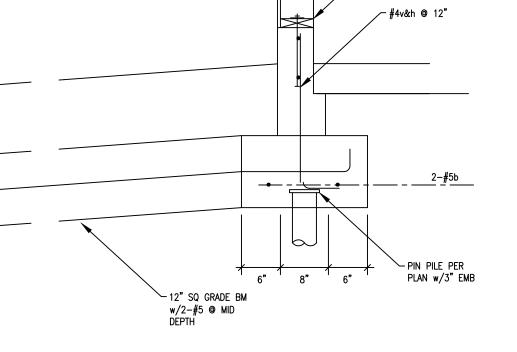


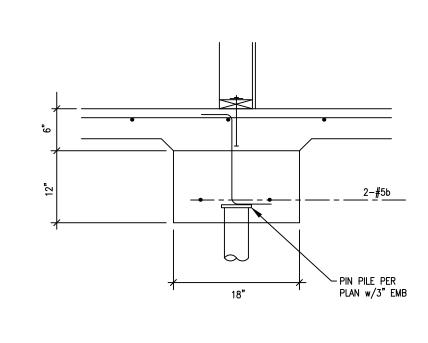

SCALE: 3/4" = 1'-0"S3.1

PT2x6 MUDSILL w/%"øx8" EMB AB ⊚ 48" OC UON ON SW SCHED / #4v&h @ 12"


S3.1 | SCALE: 3/4" = 1'-0"

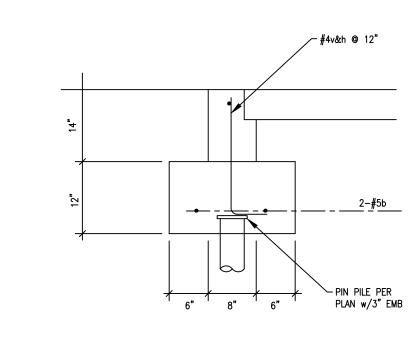

S3.1 | SCALE: 3/4" = 1'-0"

GARY GILL, SE 1125 NE 152nd STREET SHORELINE, WA 98155 PH: 206-992-2728 GILL26608@YAHOO.COM

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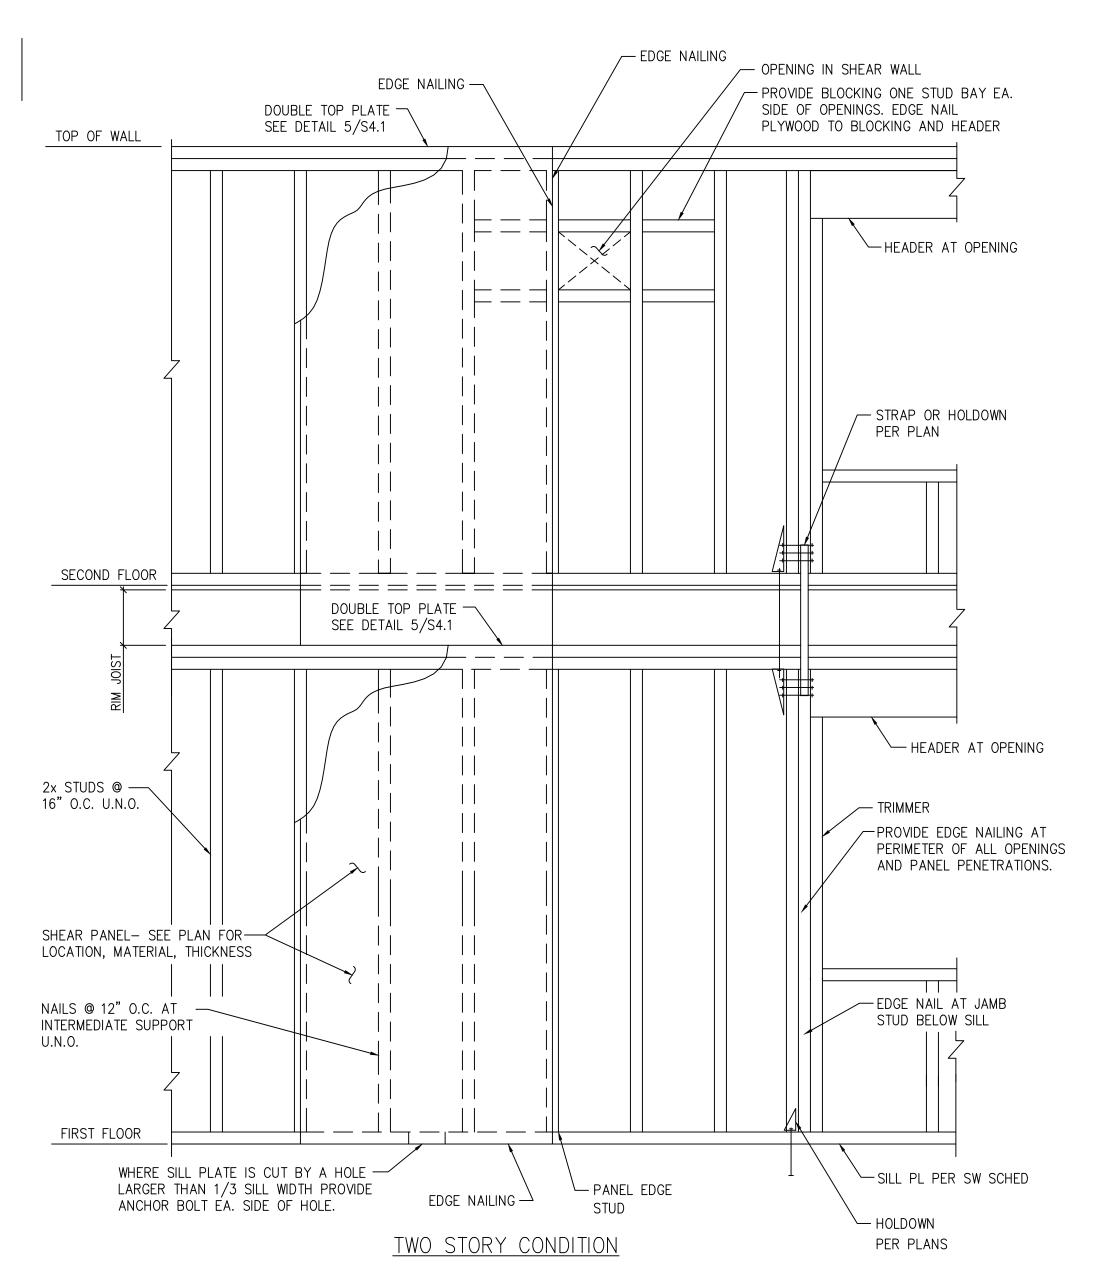
DATE:

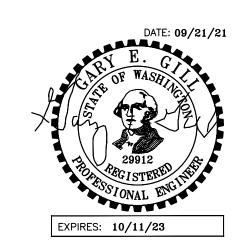21 SEPT 2021

SHEET TITLE: FOUNDATION


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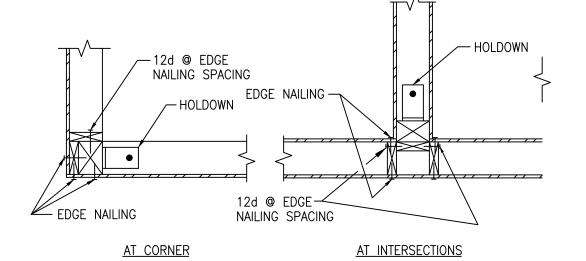
 $\int SCALE: 3/4" = 1'-0"$ SCALE: 3/4" = 1'-0"S3.1




SHEAR WALL ELEVATION $\int SCALE: 3/4" = 1'-0"$

S4.1 SCALE: 3/4" = 1'-0"



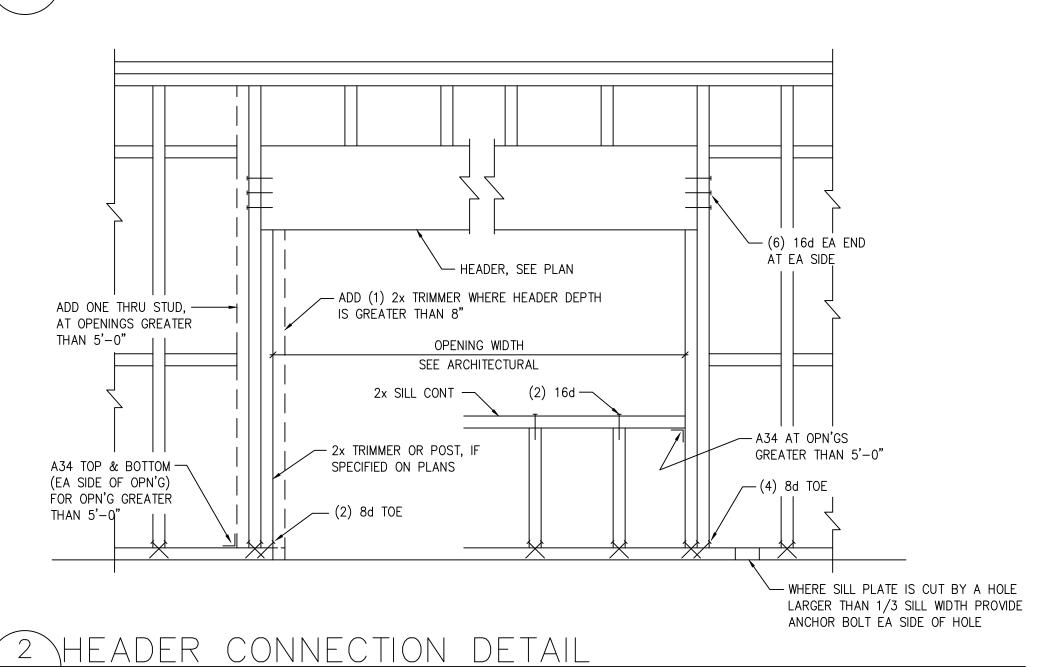


HOLDOWN PLAN VIEWS $\int SCALE: 3/4" = 1'-0"$

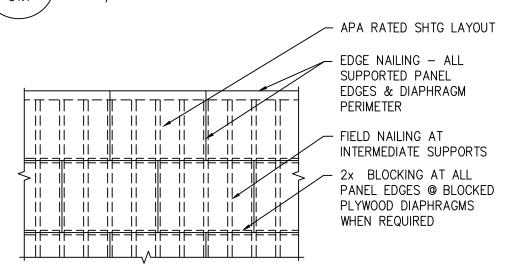

- 1. MIN EDGE DISTANCE FOR NAILS SHALL BE 3/8". 2. MIN SHEATHING SHEET SIZE SHALL BE 2'-0"x4'-0".
- 3. NAILS SHALL NOT BE OVERDRIVEN.
- 4. NAILS SHALL BE COMMON WIRE TYPE OR APPROVED EQUAL. 5. SEE PLANS FOR AREAS OF BLOCKED DIAPHRAGMS

SHEATHED DIAPHRAGM CONSTRUCTION

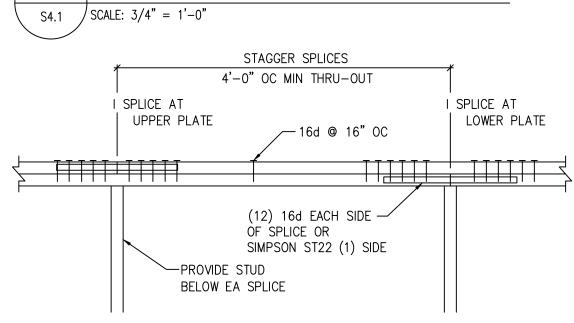

<u>ELEVATION</u>

DBL TOP PLATE SPLICE

S4.1 $\int SCALE: 3/4" = 1'-0"$

 \int SCALE: 3/4" = 1'-0"

PER PLAN

HOLD DOWN NOTES:

HOLD DOWNS ARE REQUIRED AS SHOWN ON THE FRAMING PLANS. . AT CORNERS COMMON TO TWO SHEAR WALLS USE THE LARGER OF THE HOLD DOWNS ONLY.

3. ALL HOLD DOWN COLUMNS SHALL BE DF.

4. HOLD DOWN ANCHOR BOLTS THAT OCCUR ABOVE A WF BEAM SHALL BE WELDED DIRECTLY TO THE WF BEAM BELOW SO THAT THE FULL CAPACITY OF THE ANCHOR BOLT IS

5. ALL HOLD DOWNS SHALL BE CONNECTED TO POSTS BELOW AND A BEAM BELOW. SEE 6/- FOR DETAILS. 6. ALL CALLOUTS REFER TO SIMPSON STRONGTIE PRODUCTS. OTHER MANUFACTURED HOLD DOWNS MAY BE SUBSTITUTED PROVIDED THAT TESTING DATA IS PROVIDED TO VERIFY

THAT THE VALUES LISTED WILL BE MET OR EXCEEDED.

MARK HO		ANCHOR BOLTS	STUD	MIN POST REQUIRED -	ALLOWABLE TENSION (Ibs)		
	HOLDOWN		FASTENERS		DOUG-FIR		
HD1	MSTI	18−.148x1½" EA END	18148x 1½" EA END	(2) 2x	3808		
				-	-		
				-	-		
HD2	HDU2-SDS2.5 OR MSTC48B3 @ WD BM BEL	%"ø MB FLR TO FLR SSTB16L @ CONC WALL OR FTG	6-SDS 1/4"x21/2 _ @ HDU2 38-10d _ @ MSTC	(2) 2x	3075		
				-			
				-	_		
HD3	HDU4-SDS2.5 OR %"Ø MB FLR TO FLR MSTC66B3 @ SB%x24 @ CONC WALL OR FTG WD BM BEL	OR	10-SDS 1/4"x21/2" -	(2) 2x	4565		
			@ HDU4 38-10d @ MSTC-	-	-		
				-	_		
HD4					00 000	(2)2x6	5645
	HDU5-SDS2.5	%"ø MB FLR TO FLR SB%x24 ⊚ CONC WALL OR FTG	20-SDS ¼"x2½"	-	_		
				-			
HD5		7/74 ND 510 TO 510	20 505	4X6	6970		
	HDU8-SDS2.5 **SB\%\x24 @ CONC WALL OR FTG	20-SDS 1/4"x21/2"	6x6	7870			
				-	-		
HD6	HDU14-SDS2.5	1"ø MB FLR TO FLR	36-SDS ¼"x2½"	6x6	14445		
		SB1x30 @ CONC WALL OR FTG		-	-		
				-	-		

SHEAR WALL SCHEDULE

MARK APA RATED	APA RATED SHEATHING		PANEL EDGE STUD AND BLKG	RIM JOIST OR BLOCK CONNECTION TO TOP PLATE	HEM—FIR (NORTH), BOTTOM PLATE ATTACHMENT TO WOOD BELOW	HEM-FIR (NORTH), SILL PLATE ATTACHMENT		CAPACITY (plf)	
			STOD AND BENO			ANCHOR BOLT	SILL	(۲")	
SW1	15/32" PLYWOOD SHEATHING, ONE SIDE	10d @ 6" OC	2X	A35 @ 16" OC	(2) 16d @ 16" OC OR 5/8" LAG SCREWS @ 32" OC	3/4" @ 48" OC OR @ MTL DK O.177ø PAF @ 6"	2X MIN	310	
SW2	15/32" PLYWOOD SHEATHING, ONE SIDE	10d @ 4" OC	3X MIN	A34 AND LTP4 @ 16" OC	(2) 16d @ 8" OC OR 5/8" LAG SCREWS @ 16" OC	3/4" @ 24" OC	3X MIN	460	
SW3	15/32" PLYWOOD SHEATHING, ONE SIDE	10d @ 3" OC	3X MIN	A35 AND LTP4 @ 16" OC	5/8" LAG SCREWS @ 12" OC	3/4" @ 18" OC	3X MIN	600	
SW4	15/32" PLYWOOD SHEATHING, ONE SIDE	10d @ 2" OC	3X MIN	A35 AND LTP4 @ 16" OC	5/8" LAG SCREWS @ 8" OC	3/4" @ 12" OC	3X MIN	770	
SW5	15/32" PLYWOOD SHEATHING, TWO SIDES	10d @ 3" OC	3X MIN	A35 AND LTP4 @ 8" OC	5/8" LAG SCREWS @ 4" OC	3/4" @ 8" OC	3X MIN	1200	
SW6	SIMP WOOD SHEAR WALL WSW24x7	NA	NA	PER SIMPSON	PER SIMPSON	PER SIMPSON	PER SIIMP	2770	

SHEAR WALL NOTES:
1. INSTALL PANELS EITHER HORIZONTALLY OR VERTICALLY. 2. WHERE SHEATHING IS APPLIED ON BOTH FACES OF WALL, PANEL JOINTS SHALL BE STAGGERED SO

THAT JOINTS ON OPPOSITE SIDES ARE NOT LOCATED ON THE SAME STUDS. 3. BLOCKING IS REQUIRED AT ALL PANEL EDGES.


4. PROVIDE SHEARWALL SHEATHING AND NAILING FOR THE ENTIRE LENGTH OF WALLS INDICATED ON

5. INTERMEDIATE FRAMING TO BE WITH 2X MINIMUM MEMBERS. FIELD NAILING @ 12" OC.

6. PROVIDE HOT-DIPPED GALVANIZED (ELECTRO-PLATING IS NOT ACCEPTABLE) NAILS AND CONNECTOR PLATES FOR ALL CONNECTORS IN CONTACT WITH PRESSURE TREATED FRAMING


7. WHERE BOTTOM PLATE ATTACHMENT SPECIFIES (2) ROWS OF NAILS, PROVIDE DOUBLE JOIST, RIM OR EQUAL. ATTACH PER DETAILS. 8. ALL SHEAR WALL FRAMING TO BE DF. NO OTHER SPECIES ALLOWED.

SHEAR WALL & HOLD DOWN SCHEDULES

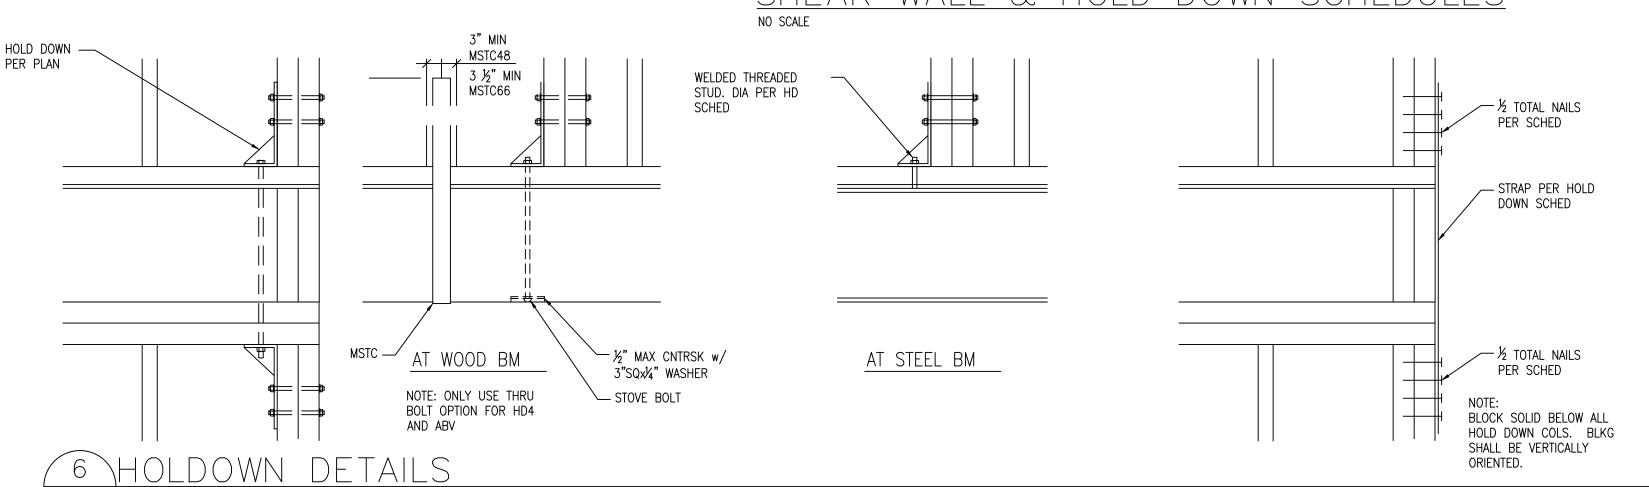

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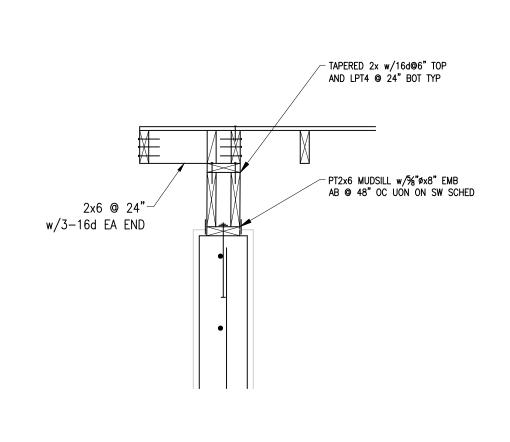
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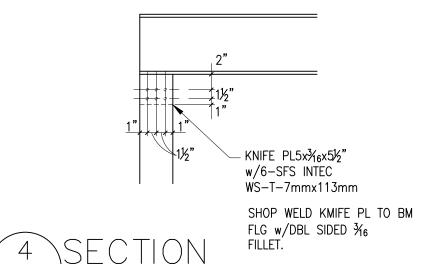
21 SEPT 2021


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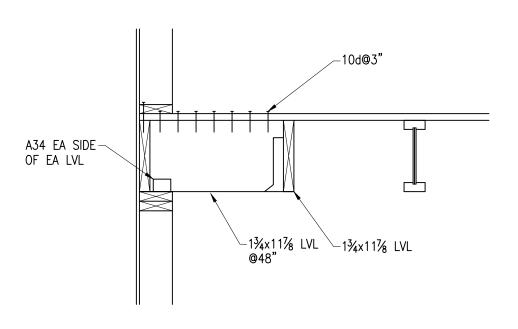
TYP FRAMING DETAILS

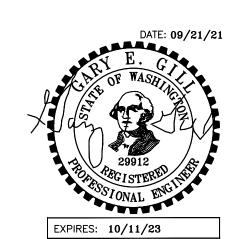
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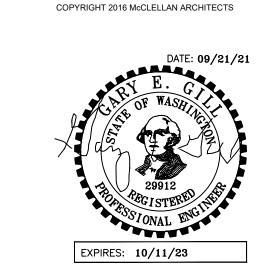






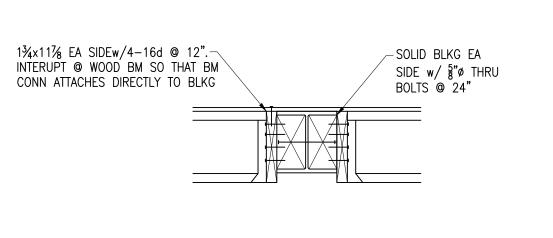

-2x6 PL w/FAST PER SW SCHED

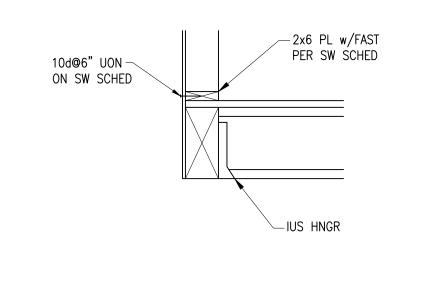

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 $\int SCALE: 3/4" = 1'-0"$







U28 HDG-

PT4x10 w/2-5%"ø-

@ 12"

GALV THRÚ BOLTS

51/4×111/8 PSL BEL-

MSTC48B3 fs

S4.2 SCALE: 3/4" = 1'-0"

 $\int SCALE: 3/4" = 1'-0"$

10d@6" UON -

ON SW SCHED

10d@6" UON —

ON SW SCHED

S4.2 $\int SCALE: 3/4" = 1'-0"$

PROJECT:


BIRD McDONALD RESIDENCE 4304 E MERCER WAY MERCER ISLAND, WA 98040

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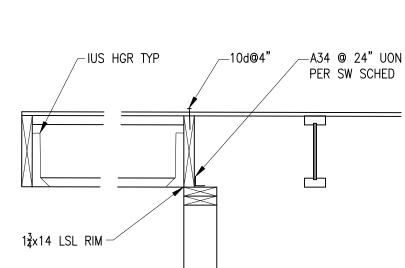



— A34 EA SIDE


OF EA RAFTER


— GLB PER PLAN

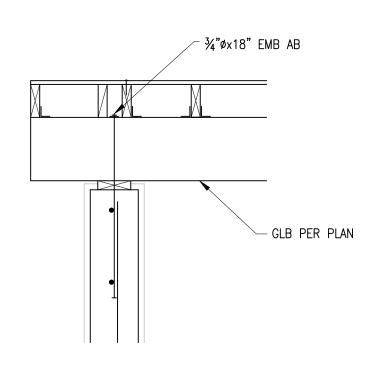




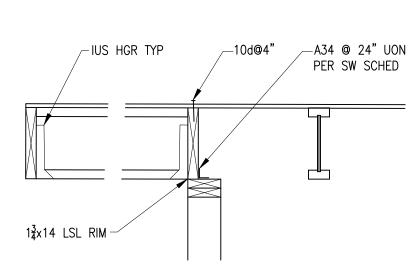


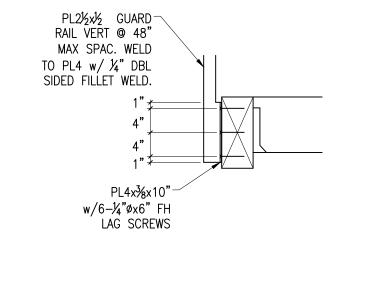


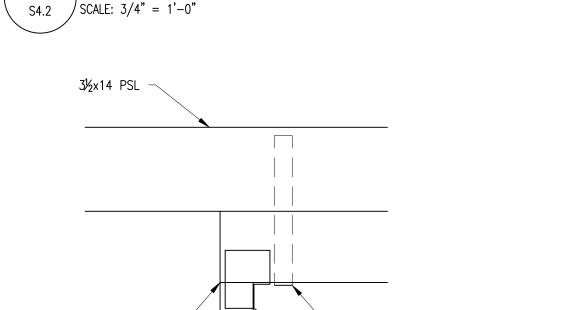

_MSTC48B3 fs

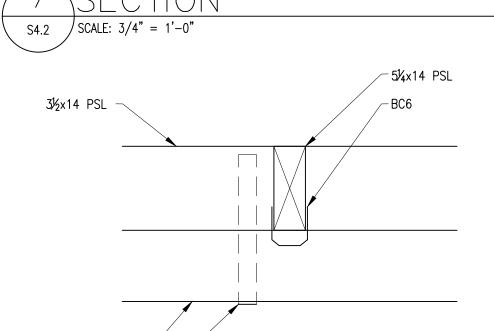


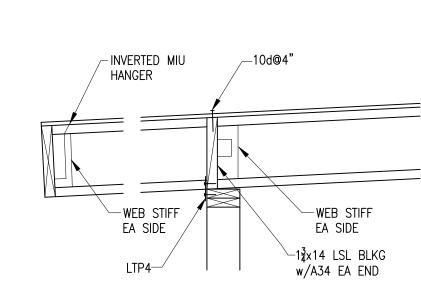

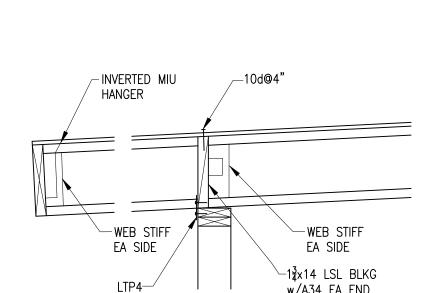




2x6 FACIA — w/3—16d @ EA RAFTER

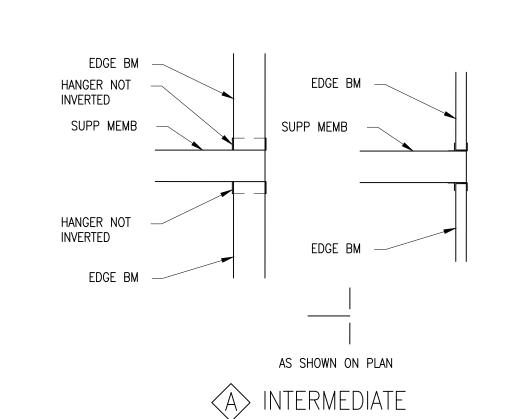




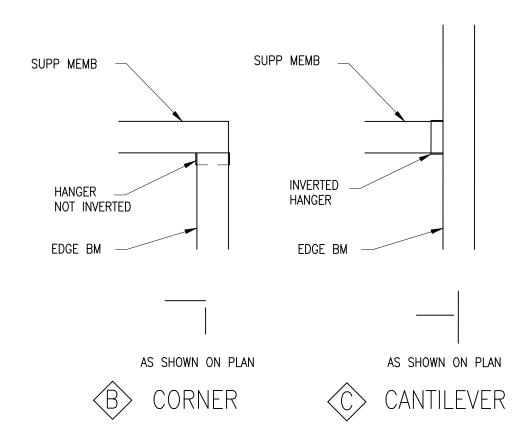


 $\frac{13}{\text{SA.2}} \frac{\text{SECTION}}{\text{SCALE: } 3/4" = 1'-0"}$

5¼x11% PSL BEL-



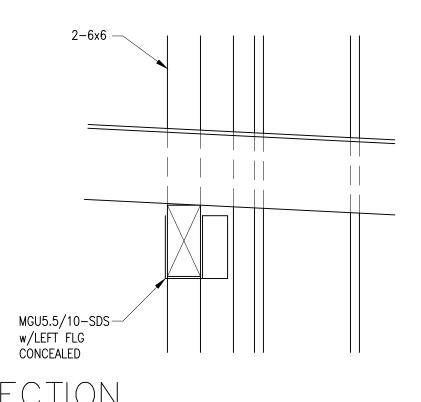

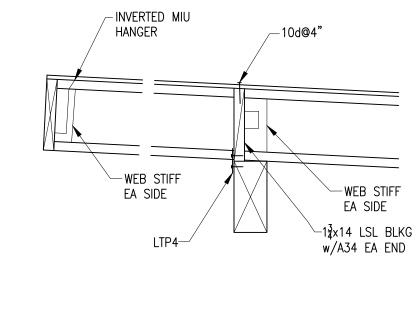



DATE:

21 SEPT 2021

SHEET TITLE:
FRAMING DETAILS

SHEET:

S4.2 SCALE: 3/4" = 1'-0"